ZONING & PARCEL INFORMATION:

APN: PARCEL TYPE: ACREAGE: ZONING: BASE YEAR: ASSESS DESC: PRINCIPAL MERIDIAN CODE PRINCIPAL MERIDIAN TEXT RANGE DIRECTION RANGE FRACTION RANGE NUMBER STATE ABBREVIATION **TOWNSHIP DIRECTION** TOWNSHIP DUPLICATE **TOWNSHIP FRACTION TOWNSHIP IDENTIFIER** TOWNSHIP LABEL TOWNSHIP NUMBER

CONSTRUCTION NOTES:

Construction work is limited to the hours of seven a.m. to seven p.m., Monday through Friday, and eight a.m. to six p.m. on Saturday. No work shall be performed on the following public holidays: New Year's Day, Independence Day, Thanksgiving, Christmas, Memorial Day or Labor Day.

LEGAL DESCRIPTION:

BUILDING AREA TABULATION:


Proposed 1st Floor =

2,300 Sq. Ft.





Sheet List	
mber	Sheet Number
COVER SHEET, ZONING	A000
1 SITE PLAN	A001
1 FLOORPLAN, DOOR AND WINDOW SCHEDU	A101
2 ROOF PLAN AND RCP	A102
3 EXTERIOR ELEVATIONS	A103
4 BUILDING SECTIONS	A104
5 BUILDING SECTIONS	A105
DOOR, WINDOW AND WALL DETAILS	A106
7 DETAILS	A107

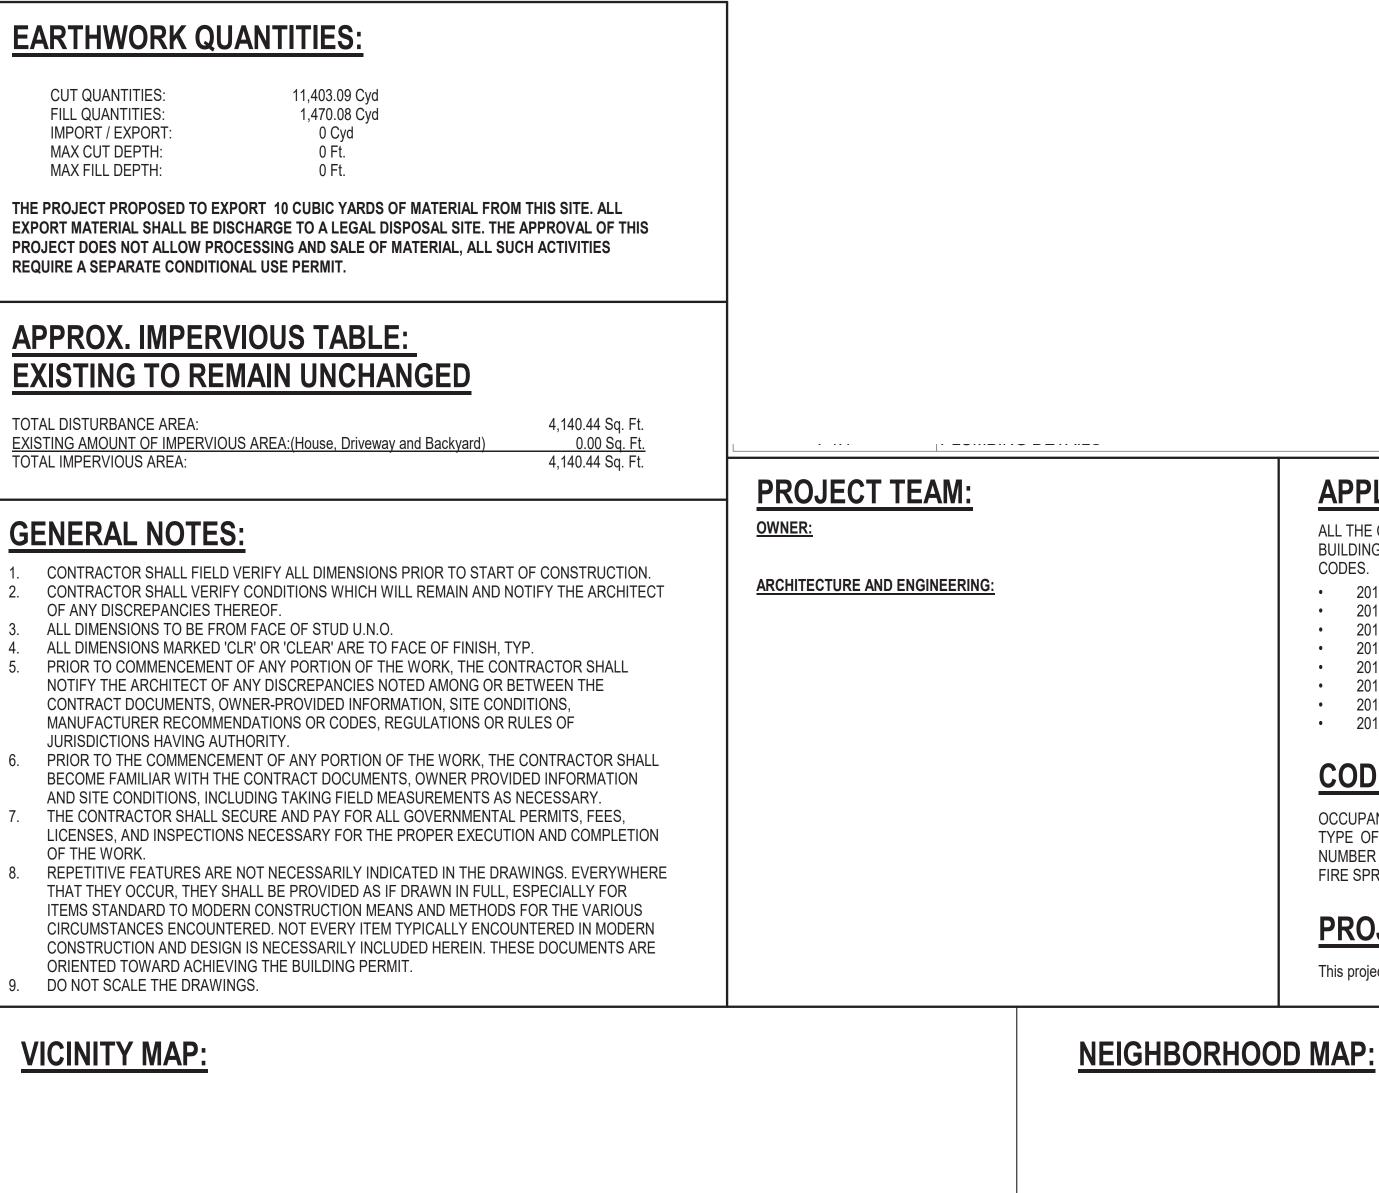



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	Sheet Name

DULES

APPLICABLE BUILDING CODES:

ALL THE CONSTRUCTION MATERIALS WILL COMPLY WITH CALIFORNIA BUILDING CODES AND REGULATIONS, AND CITY OF SAN DIEGO APPLICABLE CODES.


- 2019 California Building Code
- 2019 California Electrical Code • 2019 California Mechanical Code
- 2019 California Plumbing Code
- 2019 California Fire Code
- 2019 California Energy Code
- 2019 California Residential Code
- 2019 California Green Building Standards Code

CODE ANALYSIS:


OCCUPANCY GROUP TYPE OF CONSTRUCTION NUMBER OF STORIES FIRE SPRINKLERS


PROJECT DESCRIPTION:

This project is the design of a new 2300 SF house.

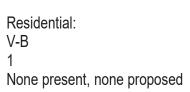



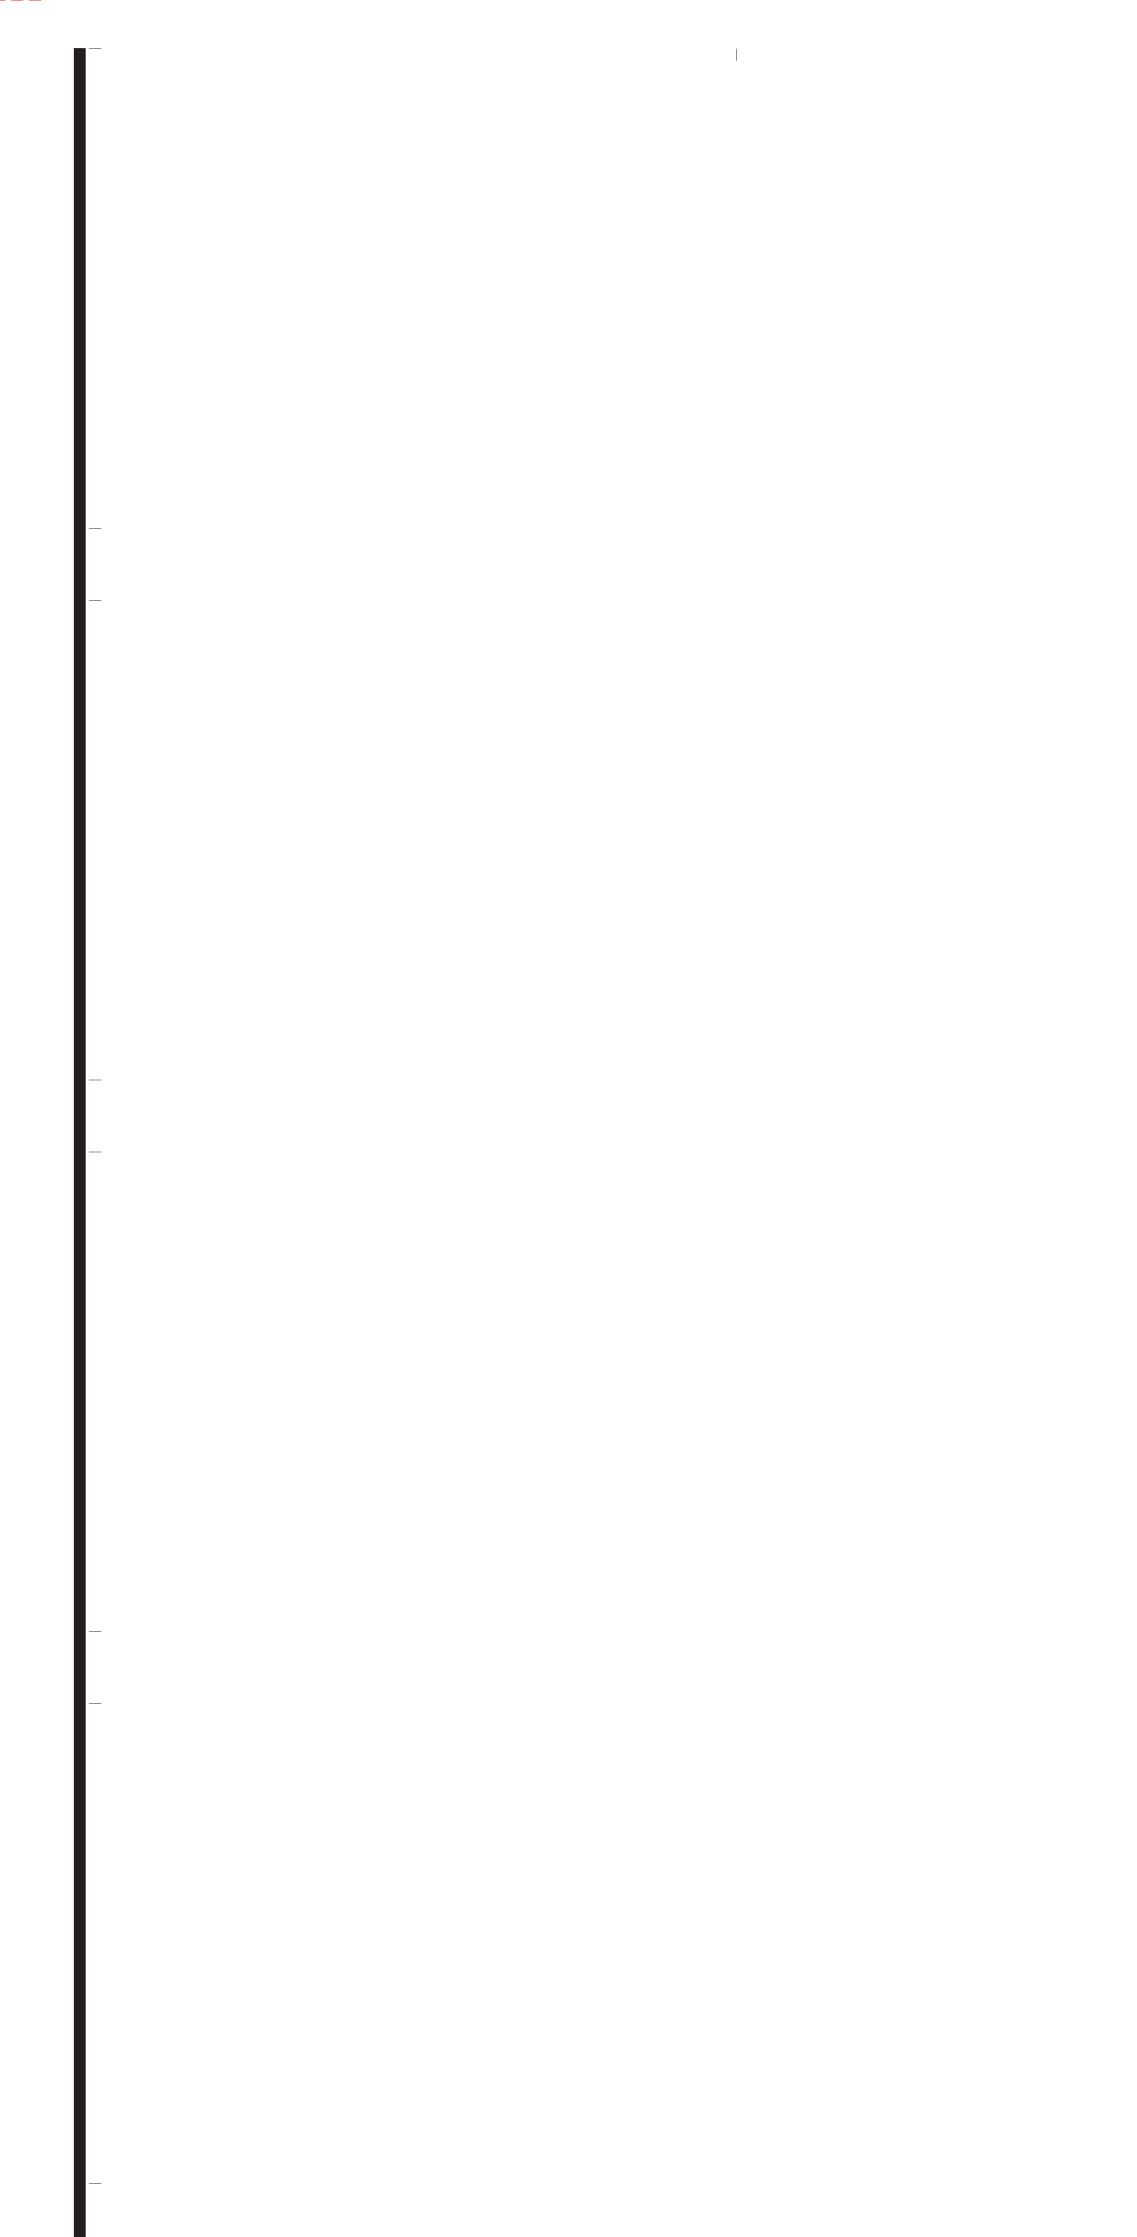

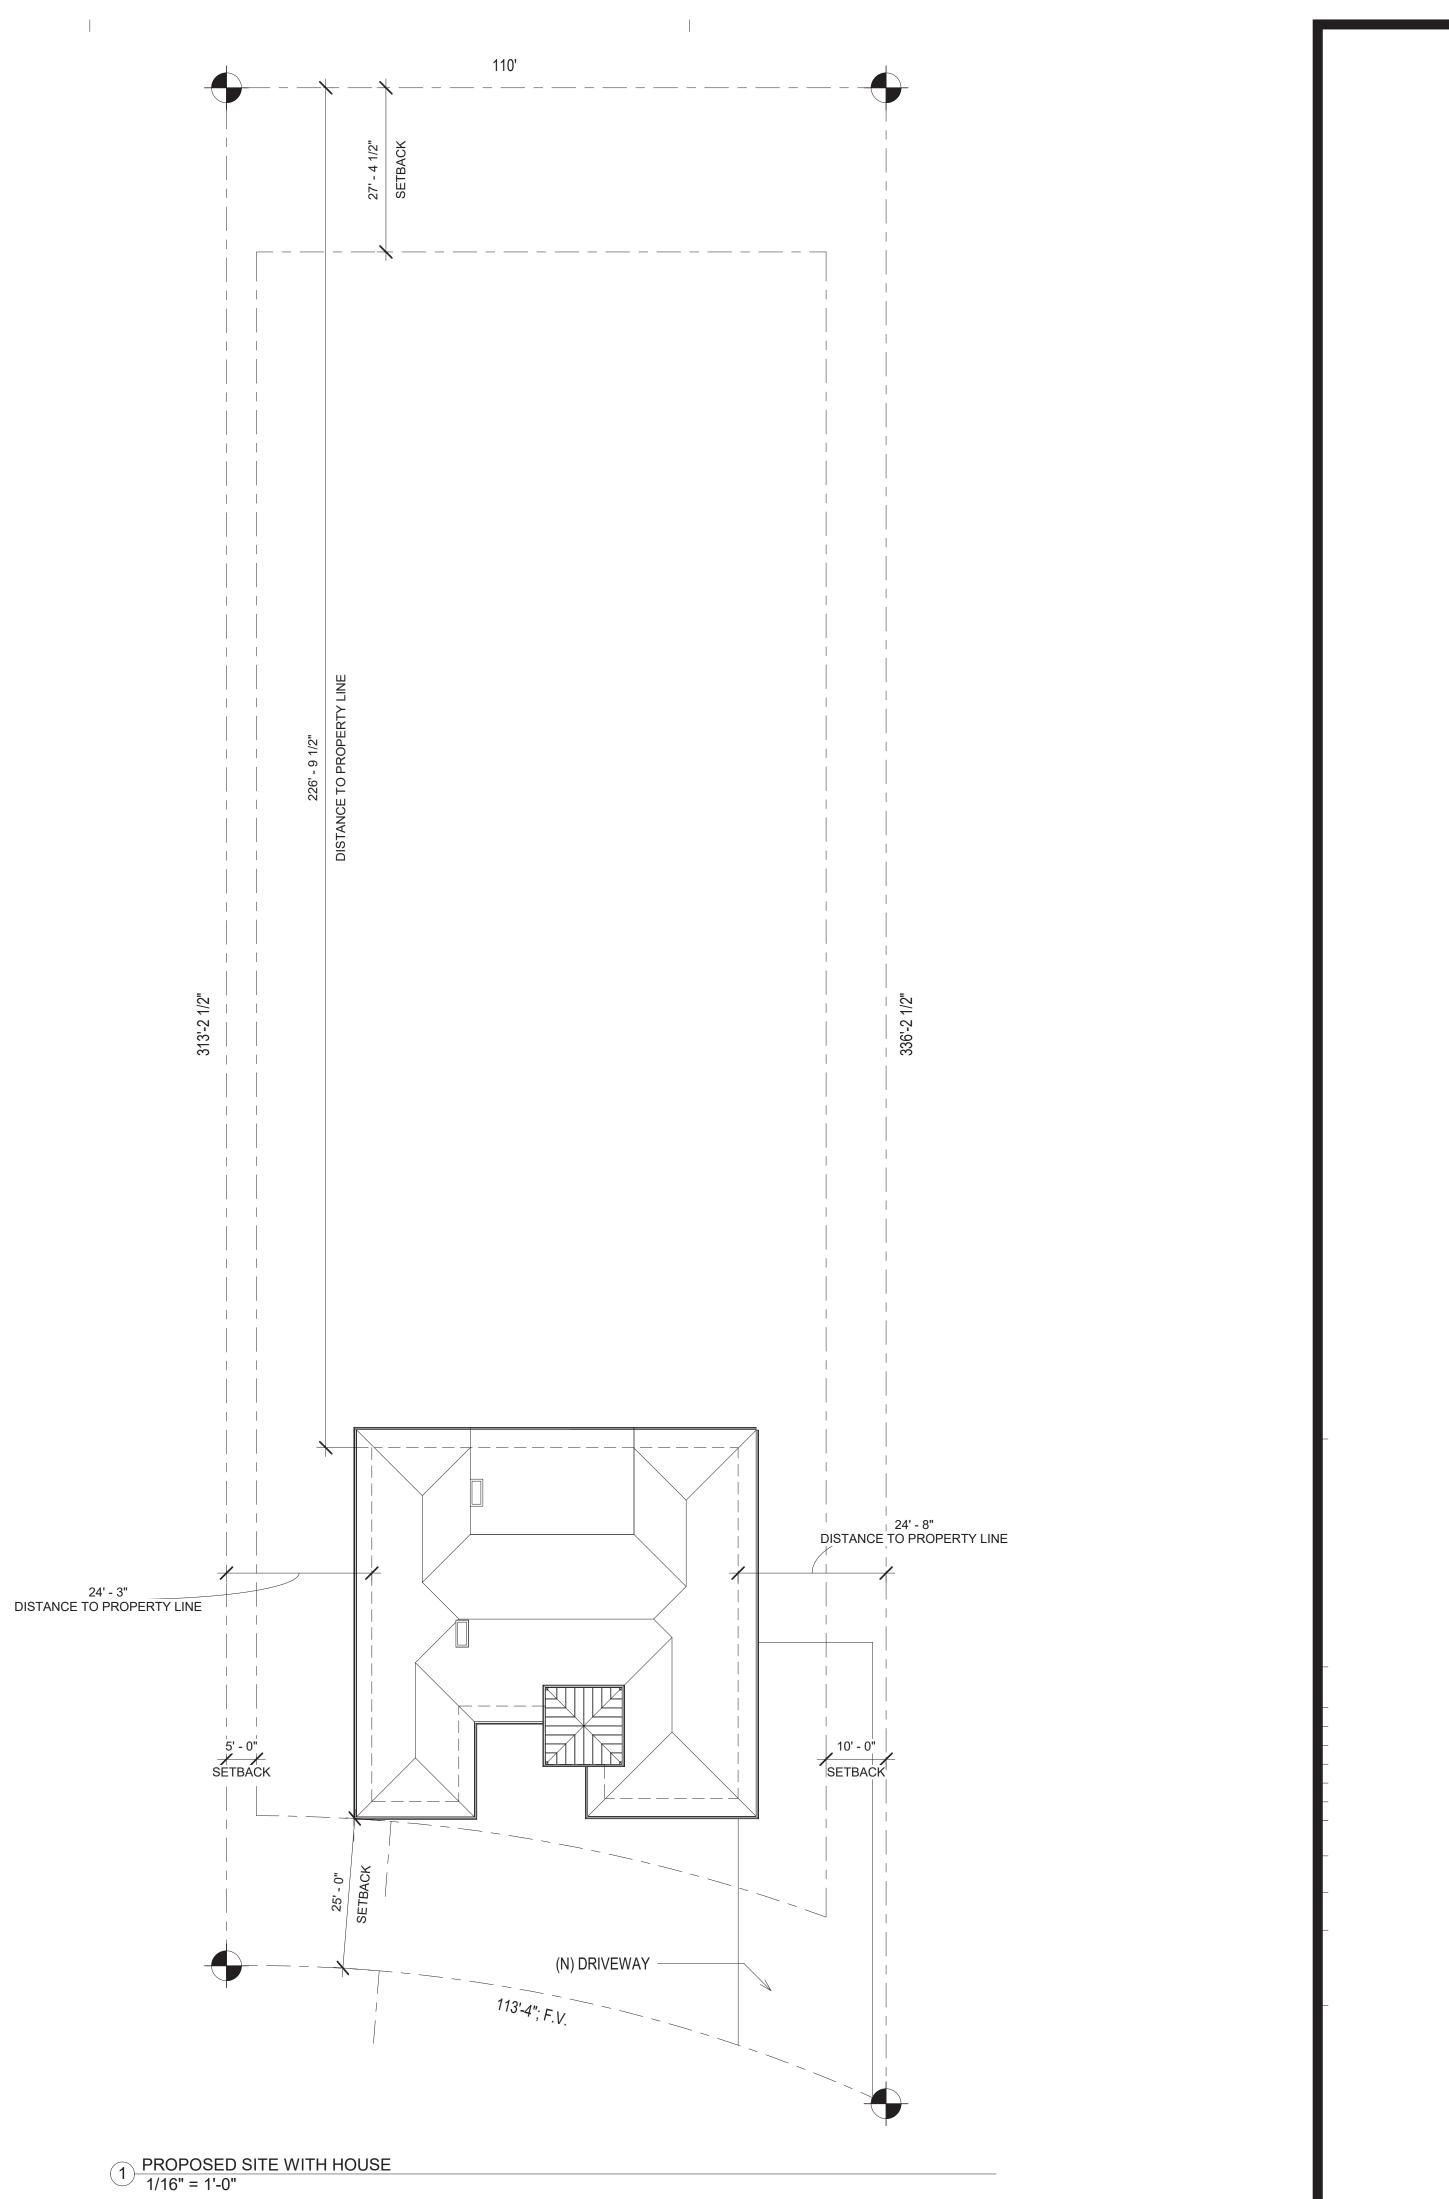

Door Schedule					
Mark	Width	Height	Comments		
1A	3' - 0"	7' - 0"			
1B	4' - 11"	7' - 0"			
3A	3' - 0"	7' - 0"			
5A	2' - 6"	6' - 8"			
5B	2' - 0"	6' - 8"			
6A	2' - 6"	7' - 0"			
7A	15' - 0"	8' - 0"			
7B	3' - 0"	7' - 0"			
7C	6' - 0"	7' - 0"			
8A	6' - 0"	7' - 0"			
8B	6' - 0"	7' - 0"			
8C	6' - 0"	7' - 0"			
8D	3' - 0"	8' - 0"			
9A	3' - 0"	7' - 0"			
9B	4' - 11"	7' - 0"			
10A	2' - 6"	7' - 0"			
11	2' - 6"	6' - 8"			
11A	3' - 0"	7' - 0"			
11B	4' - 11"	7' - 0"			
12A	2' - 6"	6' - 8"			
12B	2' - 6"	6' - 8"			
12C	4' - 11"	7' - 0"			
13A	2' - 6"	6' - 8"			


	Window Schedule						
Mark	Width	Height	Comments				
1A	2' - 0"	4' - 6"					
1B	2' - 0"	1' - 0"					
1C	1' - 0"	1' - 0"					
1D	1' - 0"	1' - 0"					
1E	1' - 0"	1' - 0"					
1F	2' - 0"	1' - 0"					
1G	2' - 0"	4' - 6"					
1H	2' - 0"	1' - 0"					
1J 1K	2' - 0" 2' - 0"	4' - 6" 1' - 0"					
1M	2 - 0"	4' - 6"					
1N	2'-0"	4' - 6"					
1P	2' - 0"	1' - 0"					
3A	2' - 0"	4' - 6"					
3B	2' - 0"	1' - 0"					
3C	2' - 0"	4' - 6"					
3D	2' - 0"	1' - 0"					
3E	2' - 0"	4' - 6"					
3F	2' - 0"	1' - 0"					
3G	2' - 0"	4' - 6"					
3H	5' - 0"	1' - 0"					
4A	2' - 0"	4' - 6"					
5A	1' - 4"	2' - 0"					
5B	4' - 6"	2' - 0"					
6A	2' - 0"	4' - 6"					
6B	2' - 0"	4' - 6"					
7A	2' - 0"	1' - 0"					
7B	2' - 0"	4' - 6"					
7C	2' - 0"	1' - 0"					
7D	2' - 0"	4' - 6"					
7E	2' - 0"	1' - 0"					
7F	2' - 0"	4' - 6"					
8A	3' - 0"	4' - 6"					
8B	3' - 0"	1' - 0"					
8C 8D	3' - 0" 3' - 0"	4' - 6" 1' - 0"					
8D 8E	3' - 0"	1' - 0"					
8F	3' - 0"	4' - 6"					
9A	2' - 0"	1' - 0"					
9B	2' - 0"	4' - 6"					
9C	2' - 0"	1' - 0"					
9D	2' - 0"	4' - 6"					
9E	2' - 0"	1' - 0"					
9F	2' - 0"	4' - 6"					
9G	2' - 0"	4' - 6"					
9H	2' - 0"	1' - 0"					
9J	2' - 0"	4' - 6"					
9K	2' - 0"	1' - 0"					
10A	1' - 0"	1' - 0"					
10B	1' - 0"	1' - 0"					
10C	1' - 0"	1' - 0"					
11A	2' - 0"	4' - 6"					
11B	2' - 0"	1' - 0"					
11C	2' - 0"	4' - 6"					
11D	2' - 0"	1' - 0"					
11E	2' - 0"	4' - 6"					
11F	2' - 0"	1' - 0"					
12A	1' - 0"	1' - 0"					
12B 12C	1' - 0" 1' - 0"	1' - 0"					
120	I - U	1' - 0"					


A103 3

1 A104

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3 A104



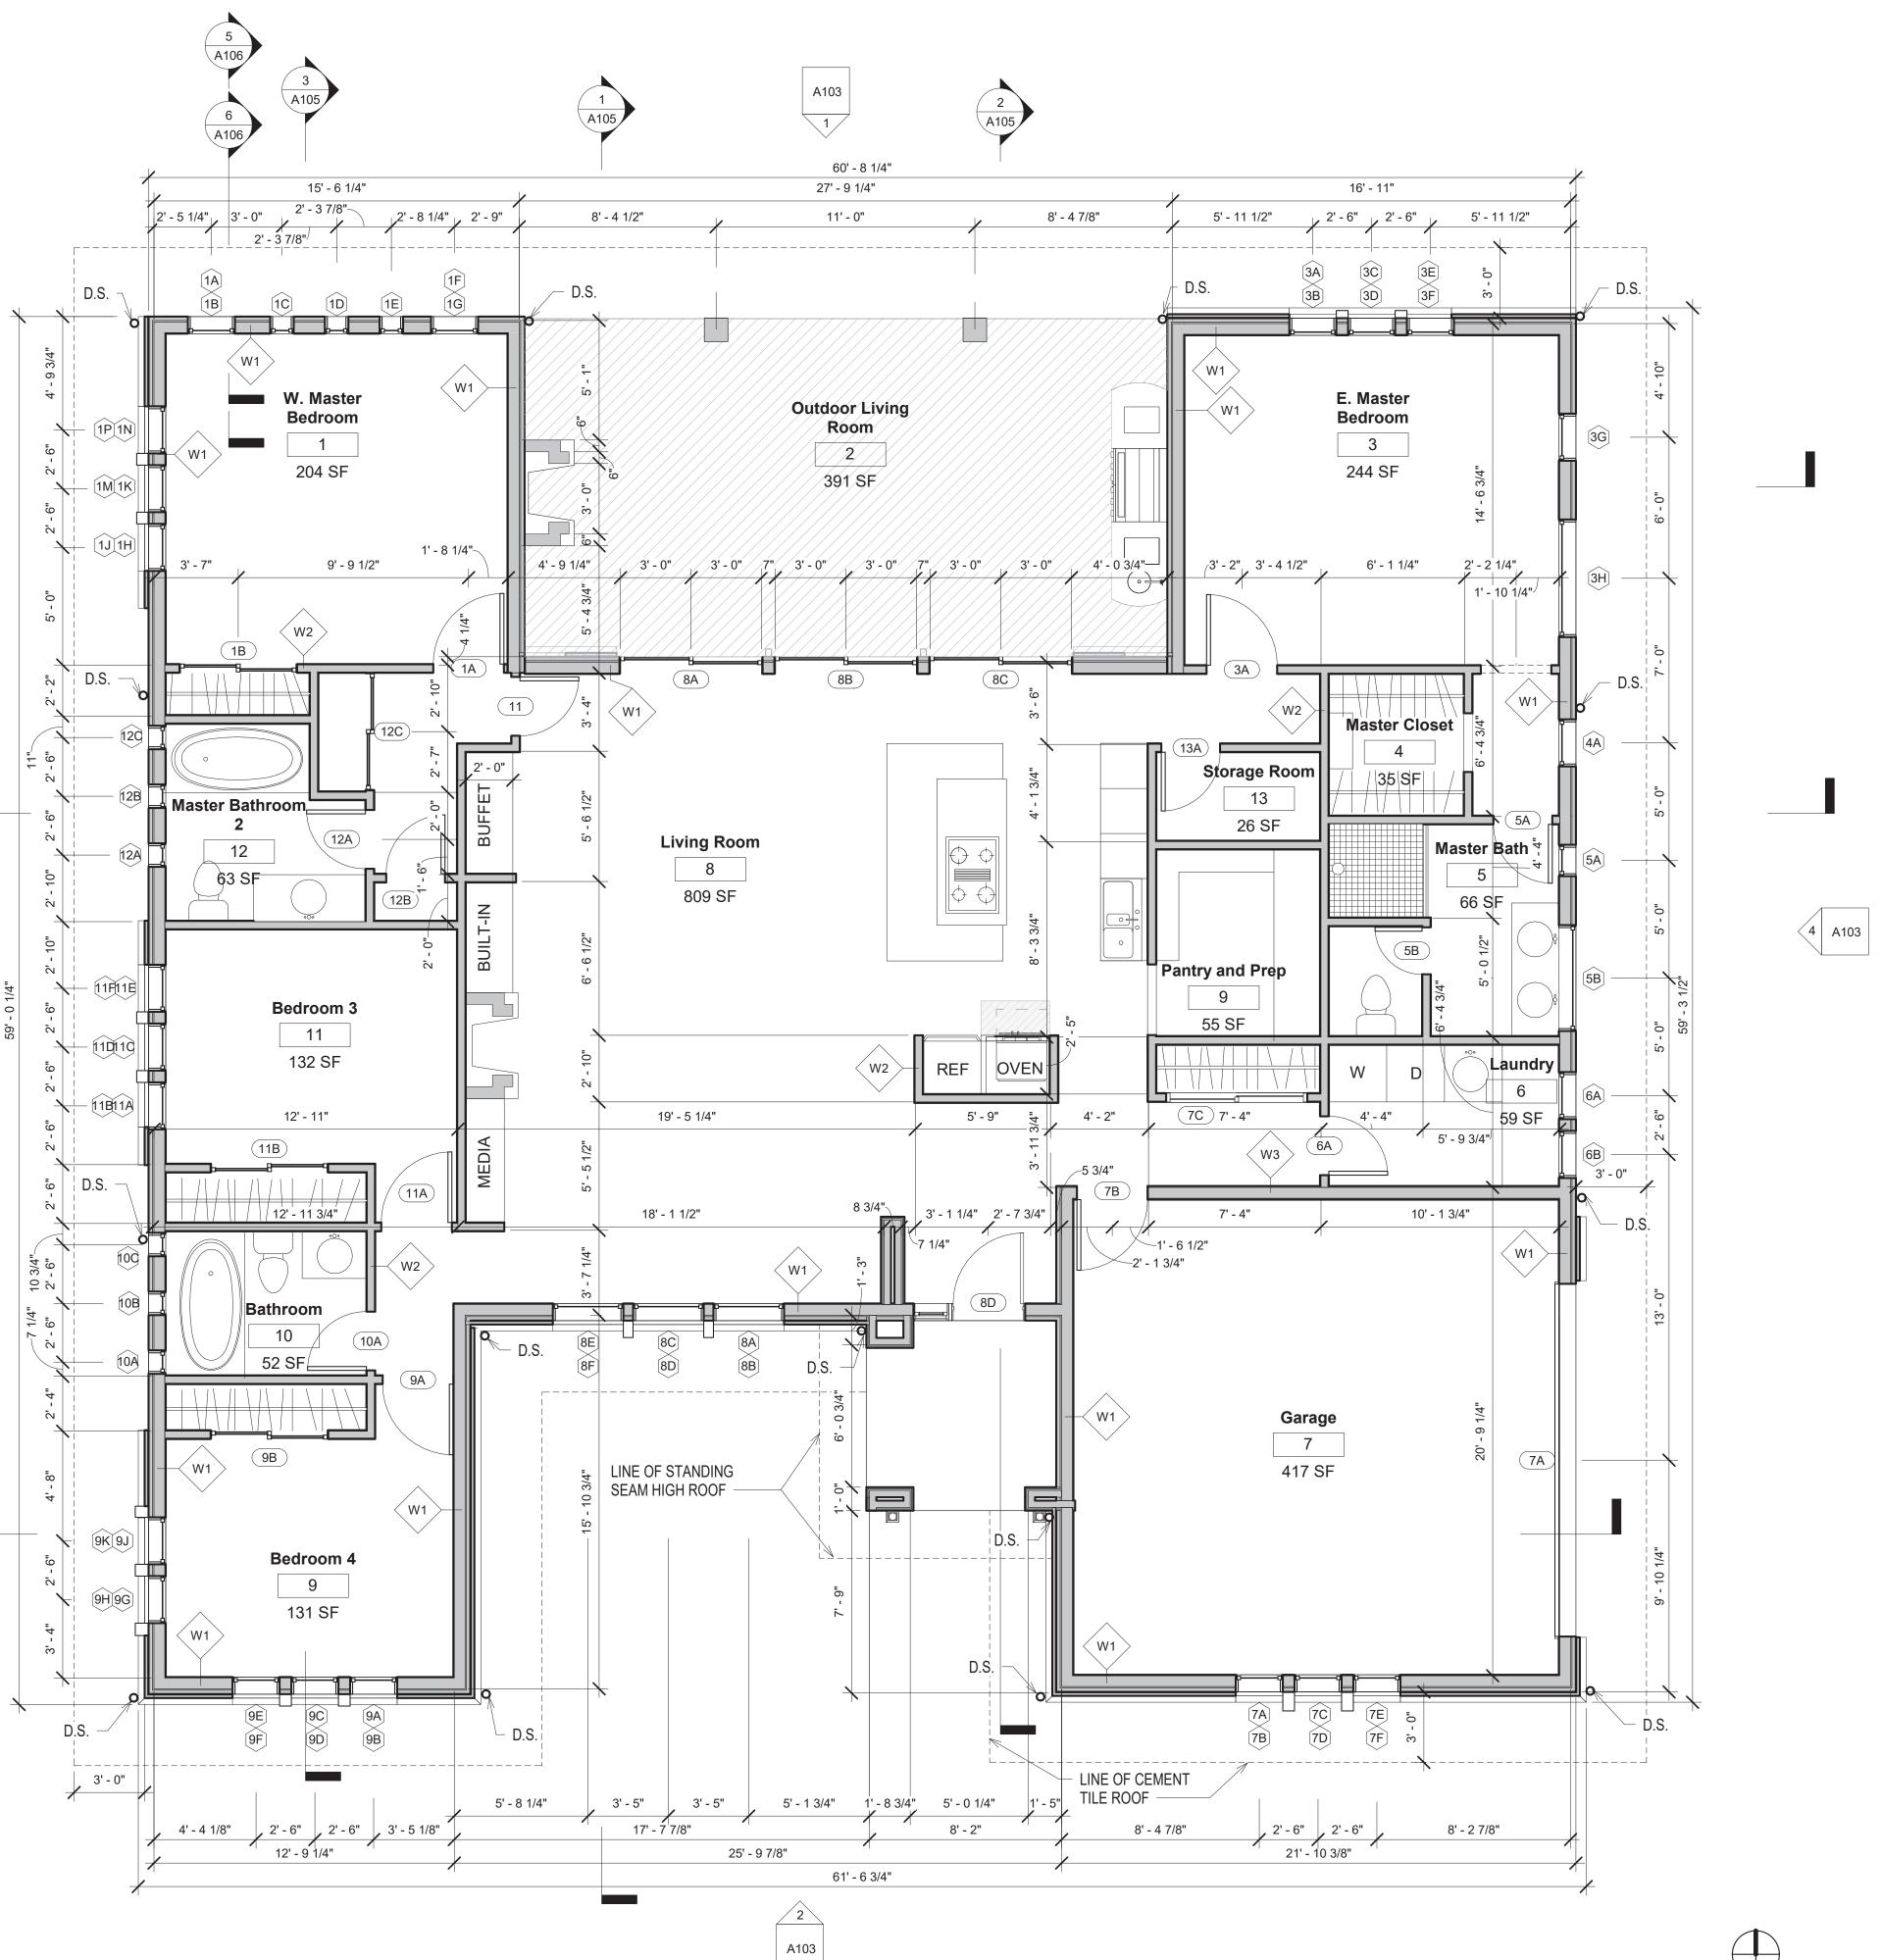

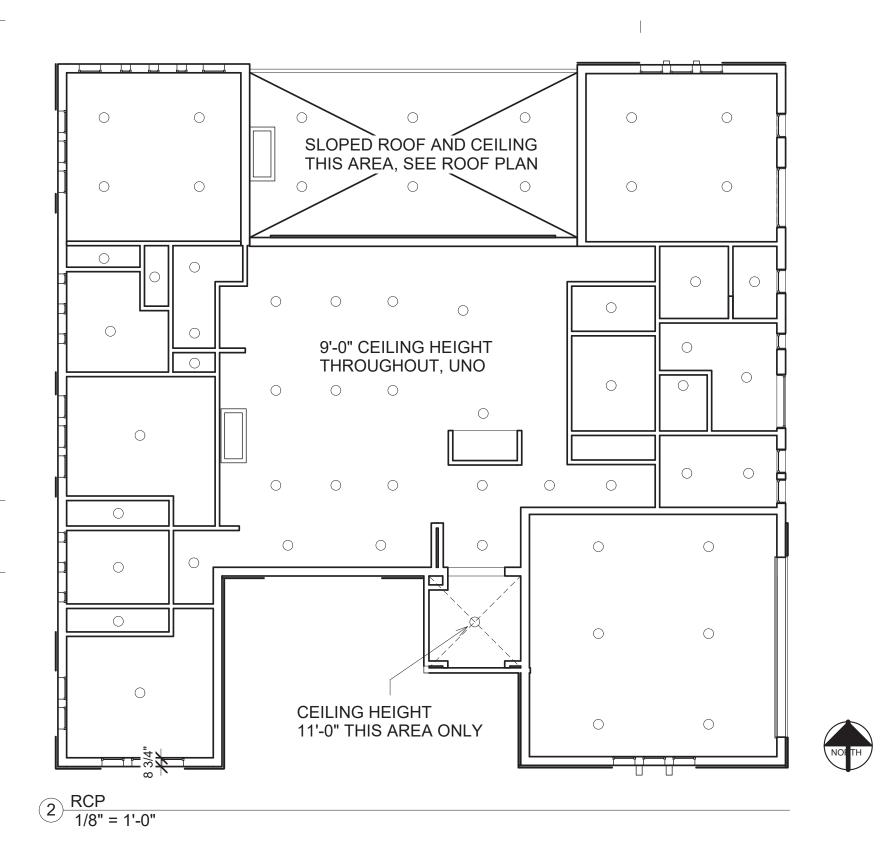REFLECTED CEILING PLAN NOTES:


INTERIOR CEILINGS: 5/8" TYPE 'X' GYP BOARD OVER WOOD FRAMING PER STRUCTURAL PLANS FOR CEILING FRAMING AND INSULATION PER MECHANICAL ENGINEER'S RECOMMENDATION.

ROOF PLAN NOTES:

- ALL ROOF AREAS SHALL SLOPE A MINIMUM 4" PER FOOT.
- FOR ROOF FRAMING REFER TO STRUCTURAL DRAWINGS. SEE STRUCTURAL DRAWINGS FOR FRAMING AND SHEATHING REQUIREMENTS.
- ROOFING MATERIAL DESCRIPTION: EAGLE LITE RED ROOF CEMENT TILES OVER 1 X 2 HORIZONTAL AND VERTICAL BATTENS OVER UNDERLAYMENT OVER 5/8" PLYWOOD SHEATHING, PER STRUCTURAL PLANS, AND PER MANUFACTURER'S SPECIFICATIONS.
- STANDING SEAM ROOF, PER CONTRACTOR'S SELECTION TO BE INSTALLED PER MANUFACTURER'S RECOMMENDATION.


GENERAL NOTES:


- ALL HORIZONTAL AND VERTICAL DIMENSIONS TO BE VERIFIED IN THE FIELD PRIOR TO ANY WORK.
- EXTERIOR IS FINISHED WITH 7/8" EXTERIOR PLASTER (THREE COATS) OVER SELF-FURRING DIAMOND MESH OVER 2- LAYERS OF GRADE 'D' PAPER ON PLYWOOD WITH R-21 BATT INSULATION.
- INTERIOR WALLS 2 X 4 WOOD STUDS AT 16" O.C. TO THE UNDERSIDE OF THE ROOF FRAMING WITH 5/8" TYPE 'X' GYPSUM BOARD EACH SIDE FULL HEIGHT WITH BATT INSULATION. SLOPE FINISHED EXTERIOR DECK AWAY FROM BUILDING 2% MAXIMUM AND 1% MINIMUM.
- ALL OCCUPIABLE SPACES TO BE INSULATED WITH MINIMUM R-21 IN EXTERIOR WALLS AND R-30 IN ATTIC CEILING / ROOF SPACES.
- REFER TO STRUCTURAL PLANS FOR SIZES AND CONNECTIONS OF ALL STRUCTURAL ELEMENTS.
- THE PURPOSE OF ALL BUILDING SECTIONS IS TO CLARIFY DESIGN INTENT. REFER TO FLOOR PLANS, REFLECTED CEILING PLANS, ROOF PLANS, AND ELEVATIONS PRIOR TO COMMENCING OR PROCEDING WITH THE WORK.
- CONCRETE SLAB AND ROOF FRAMING, SEE STRUCTURAL DRAWINGS.
- NOTIFY ARCHITECT IF ANY INCONSISTENCIES OR DISCREPANCIES FOUND WITHIN PLANS IN RELATION TO EXISTING FIELD CONDITIONS. WRITTEN DIMENSIONS IN CONSTRUCTION DOCUMENTS TAKE PRECEDENCE OVER ANY SCALED DRAWINGS. 10
- DIMENSIONS ARE FROM THE FACE OF FINISH WALL (GWB) TO FACE OF FINISH WALL (GWB), UNLESS OTHERWISE NOTED ON DRAWINGS. 11 12. ALL MANUFACTURED ARTICLES, MATERIALS AND EQUIPMENT SHALL BE APPLIED, INSTALLED, CONNECTED, ERECTED, CLEANED AND CONDITIONS
- IN ACCORDANCE WITH THE MANUFACTURER'S WRITTEN SPECIFICATIONS / OR INSTRUCTIONS 13. ALL WORK SHALL BE EXECUTED IN A MANNER ACCEPTABLE TO THE OWNER, UNLESS OTHERWISE NOTED. THE GENERAL CONTRACTOR SHALL
- PROVIDE AND PAY FOR ALL LABOR, MATERIALS, EQUIPMENT, TOOLS, CONSTRUCTION EQUIPMENT, MACHINERY, TRANSPORTATION, AND OTHER SERVICES AND FACILITIES NECCESSARY FOR PROPER AND TIMELY EXECUTION OF WORK.
- 14. THE CONTRACTOR WARRANTS TO THE OWNER THAT ALL MATERIALS AND EQUIPMENT FURNISHED UNDER THE CONTRACT ARE NEW UNLESS OTHERWISE SPECIFIED, AND THAT ALL WORK SHALL BE AS SPECIFIED AND FREE OF DEFECTS.
- 15. ALL OUTSIDE CORNERS AT DRYWALL PARTITIONS AND FURRING TO HAVE METAL CORNER BEADS, SPACKLE AND SMOOTH. 16
- PROVIDE DIAGONAL BRACING TO STRUCTURE ABOVE ALL NEW DOORS, GLAZING HEADS AND JAMBS, AS REQUIRED TO MAKE ASSEMBLY RIGID. 17. THE GENERAL CONTRACTOR IS RESPONSIBLE FOR THE FINAL CLEANUP OF THE AREA OF WORK AND AREA AFFECTED BY CONSTRUCTION, TO
- INCLUDE, BUT NOT LIMITED TO FLOORS, MILLWORK, FIXTURES, ETC., FOLLOWING THE INSTALLATION OF THE MILLWORK. 18. THE GENERAL CONTRACTOR SHALL COORDINATE THE LOCATIONS FOR THE WALL MOUNTED TELEVISION AND GRAPHIC SIGNAGE TO PROVIDE BLOCKING FOR MOUNTING.
- 19. ALL WET PLUMBING WALLS ARE TO BE PROVIDED WITH MOISTURE RESISTANT GYP BOARD. UNLESS TILE IS TO BE USED THEN PROVIDE CEMENT BACKER BOARD.

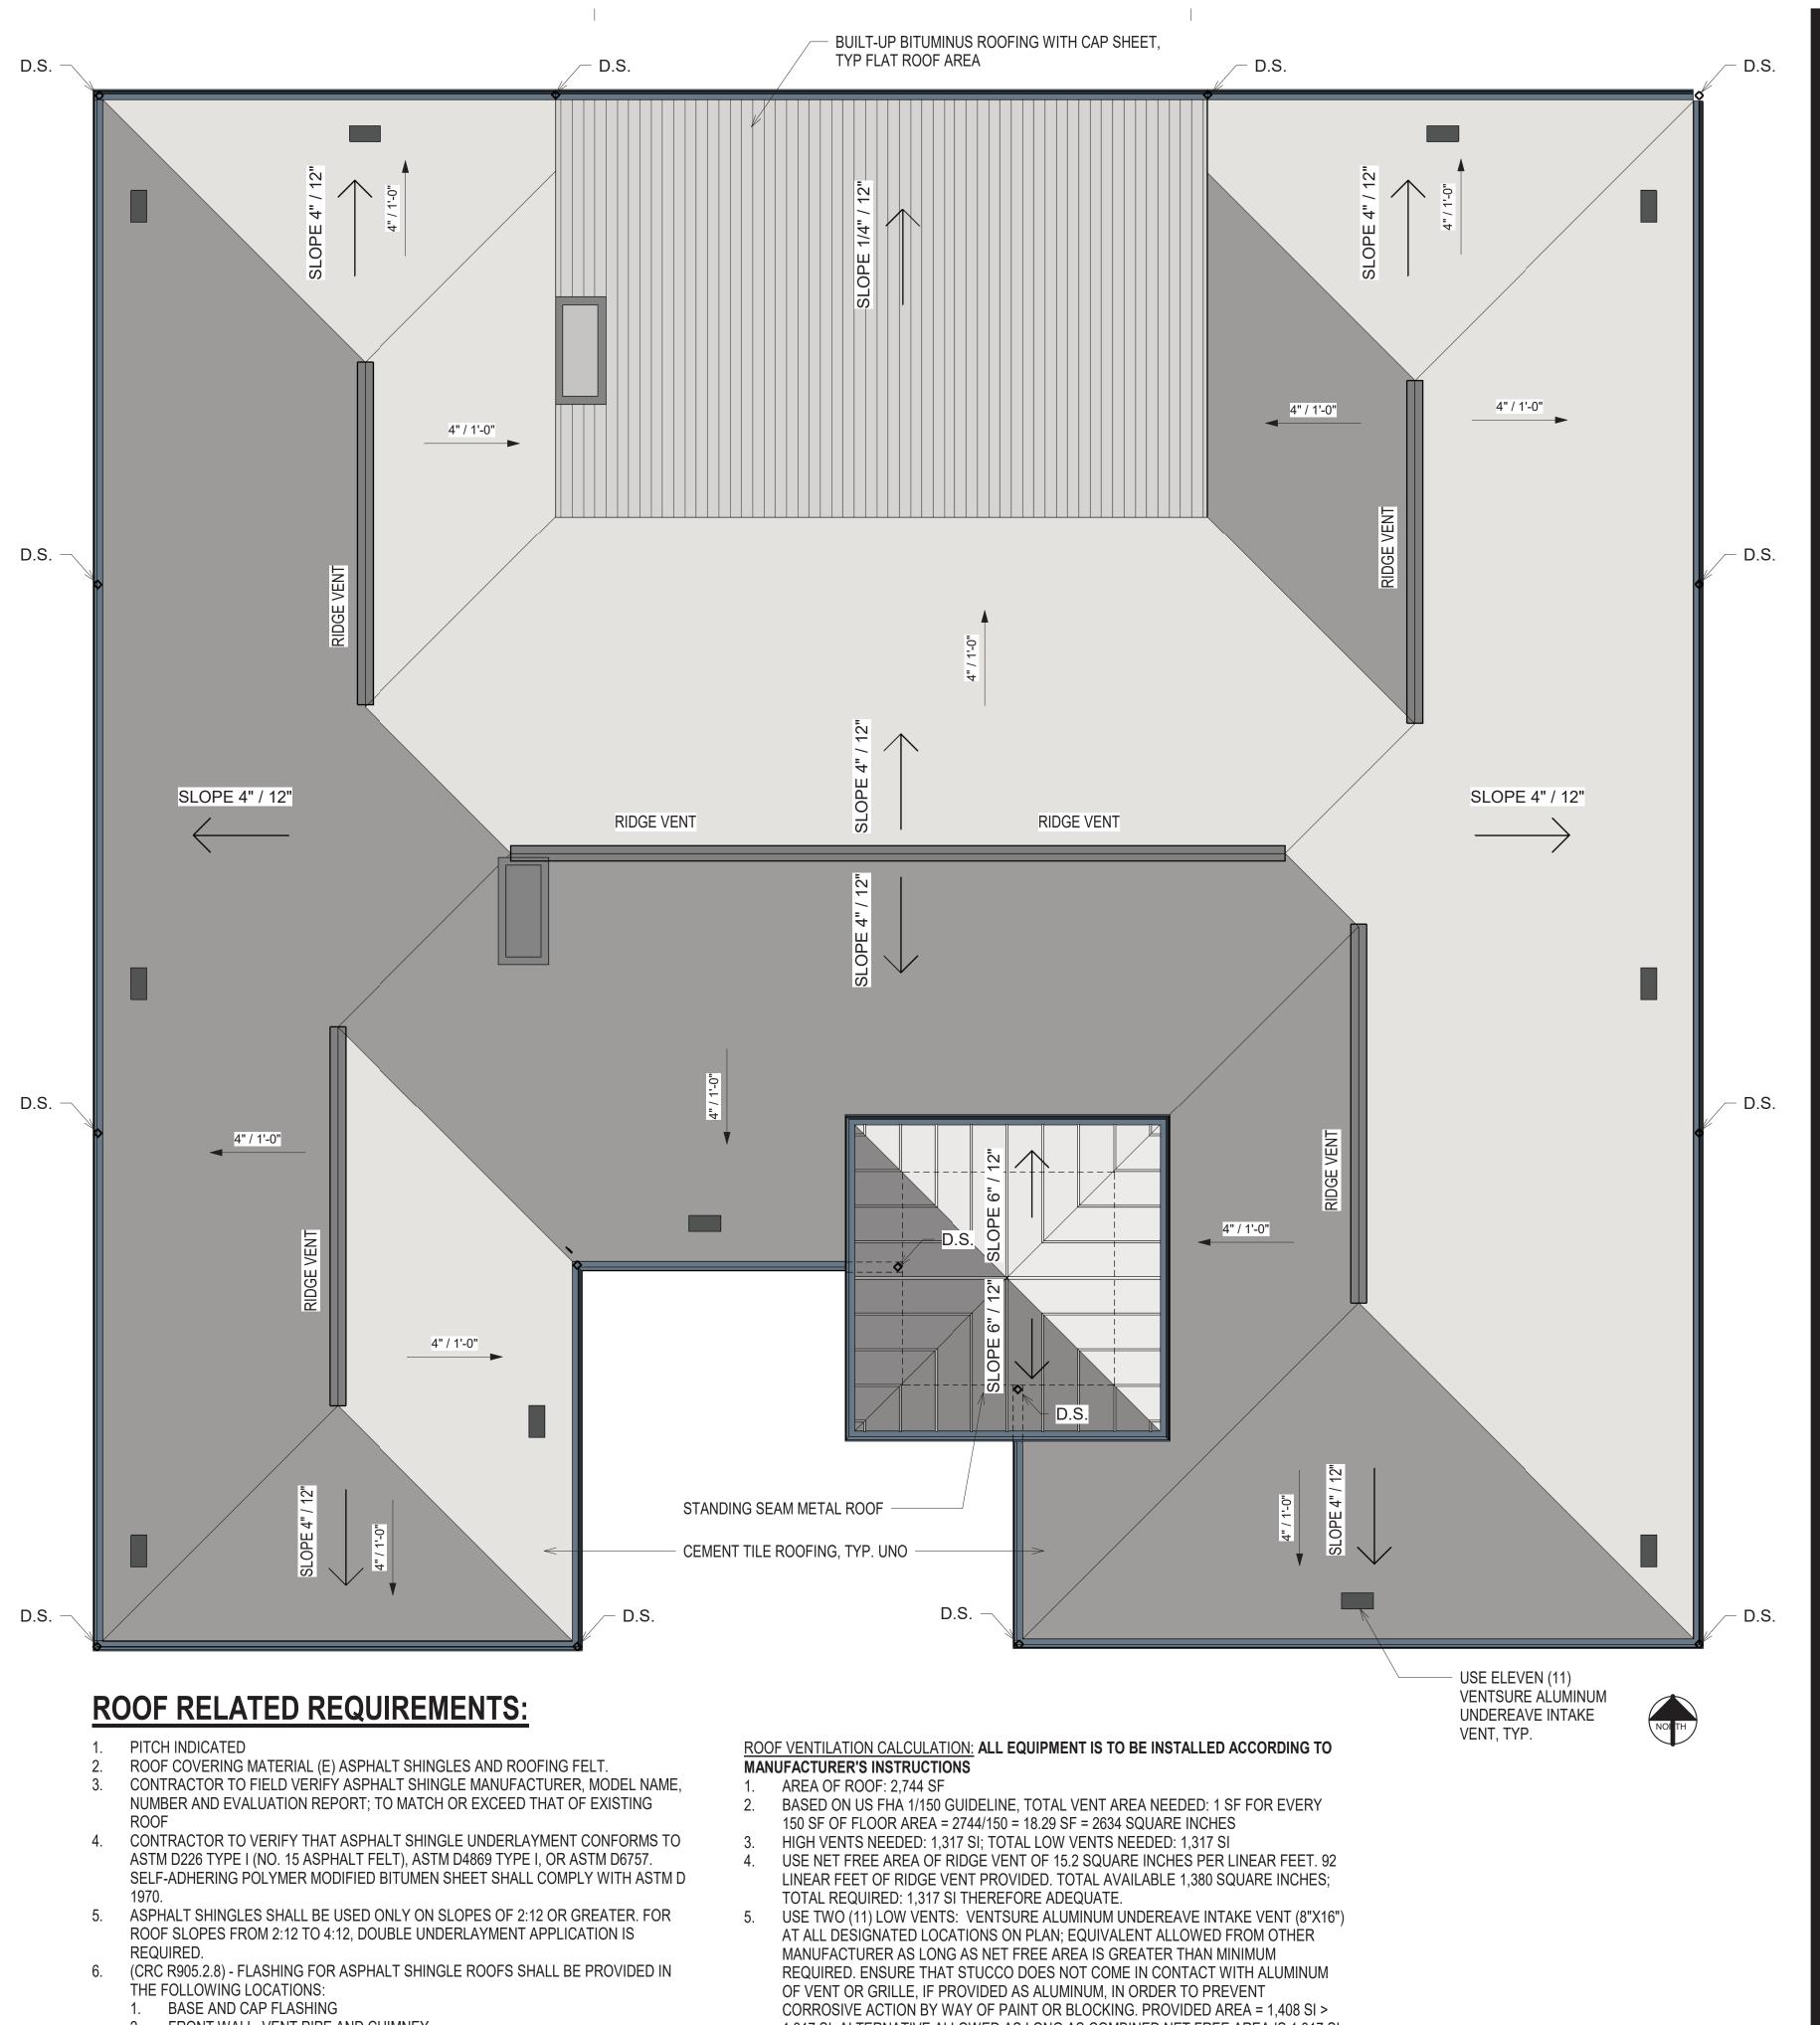


- - FRONT WALL, VENT PIPE AND CHIMNEY
 - DRIP EDGE AT EAVES AND GABLES
- 7. CLASS 'A' ROOF ASSEMBLY IS ONE TESTED IN ACCORDANCE WITH ASTM E 108 OR UL 790. THE MINIMUM ROOF COVERINGS INSTALLED ON BUILDINGS SHALL COMPLY WITH TABLE 1505.1 BASED ON THE TYPE OF CONSTRUCTION OF THE BUILDING.


- 1,317 SI. ALTERNATIVE ALLOWED AS LONG AS COMBINED NET FREE AREA IS 1.317 SI OR GREATER.

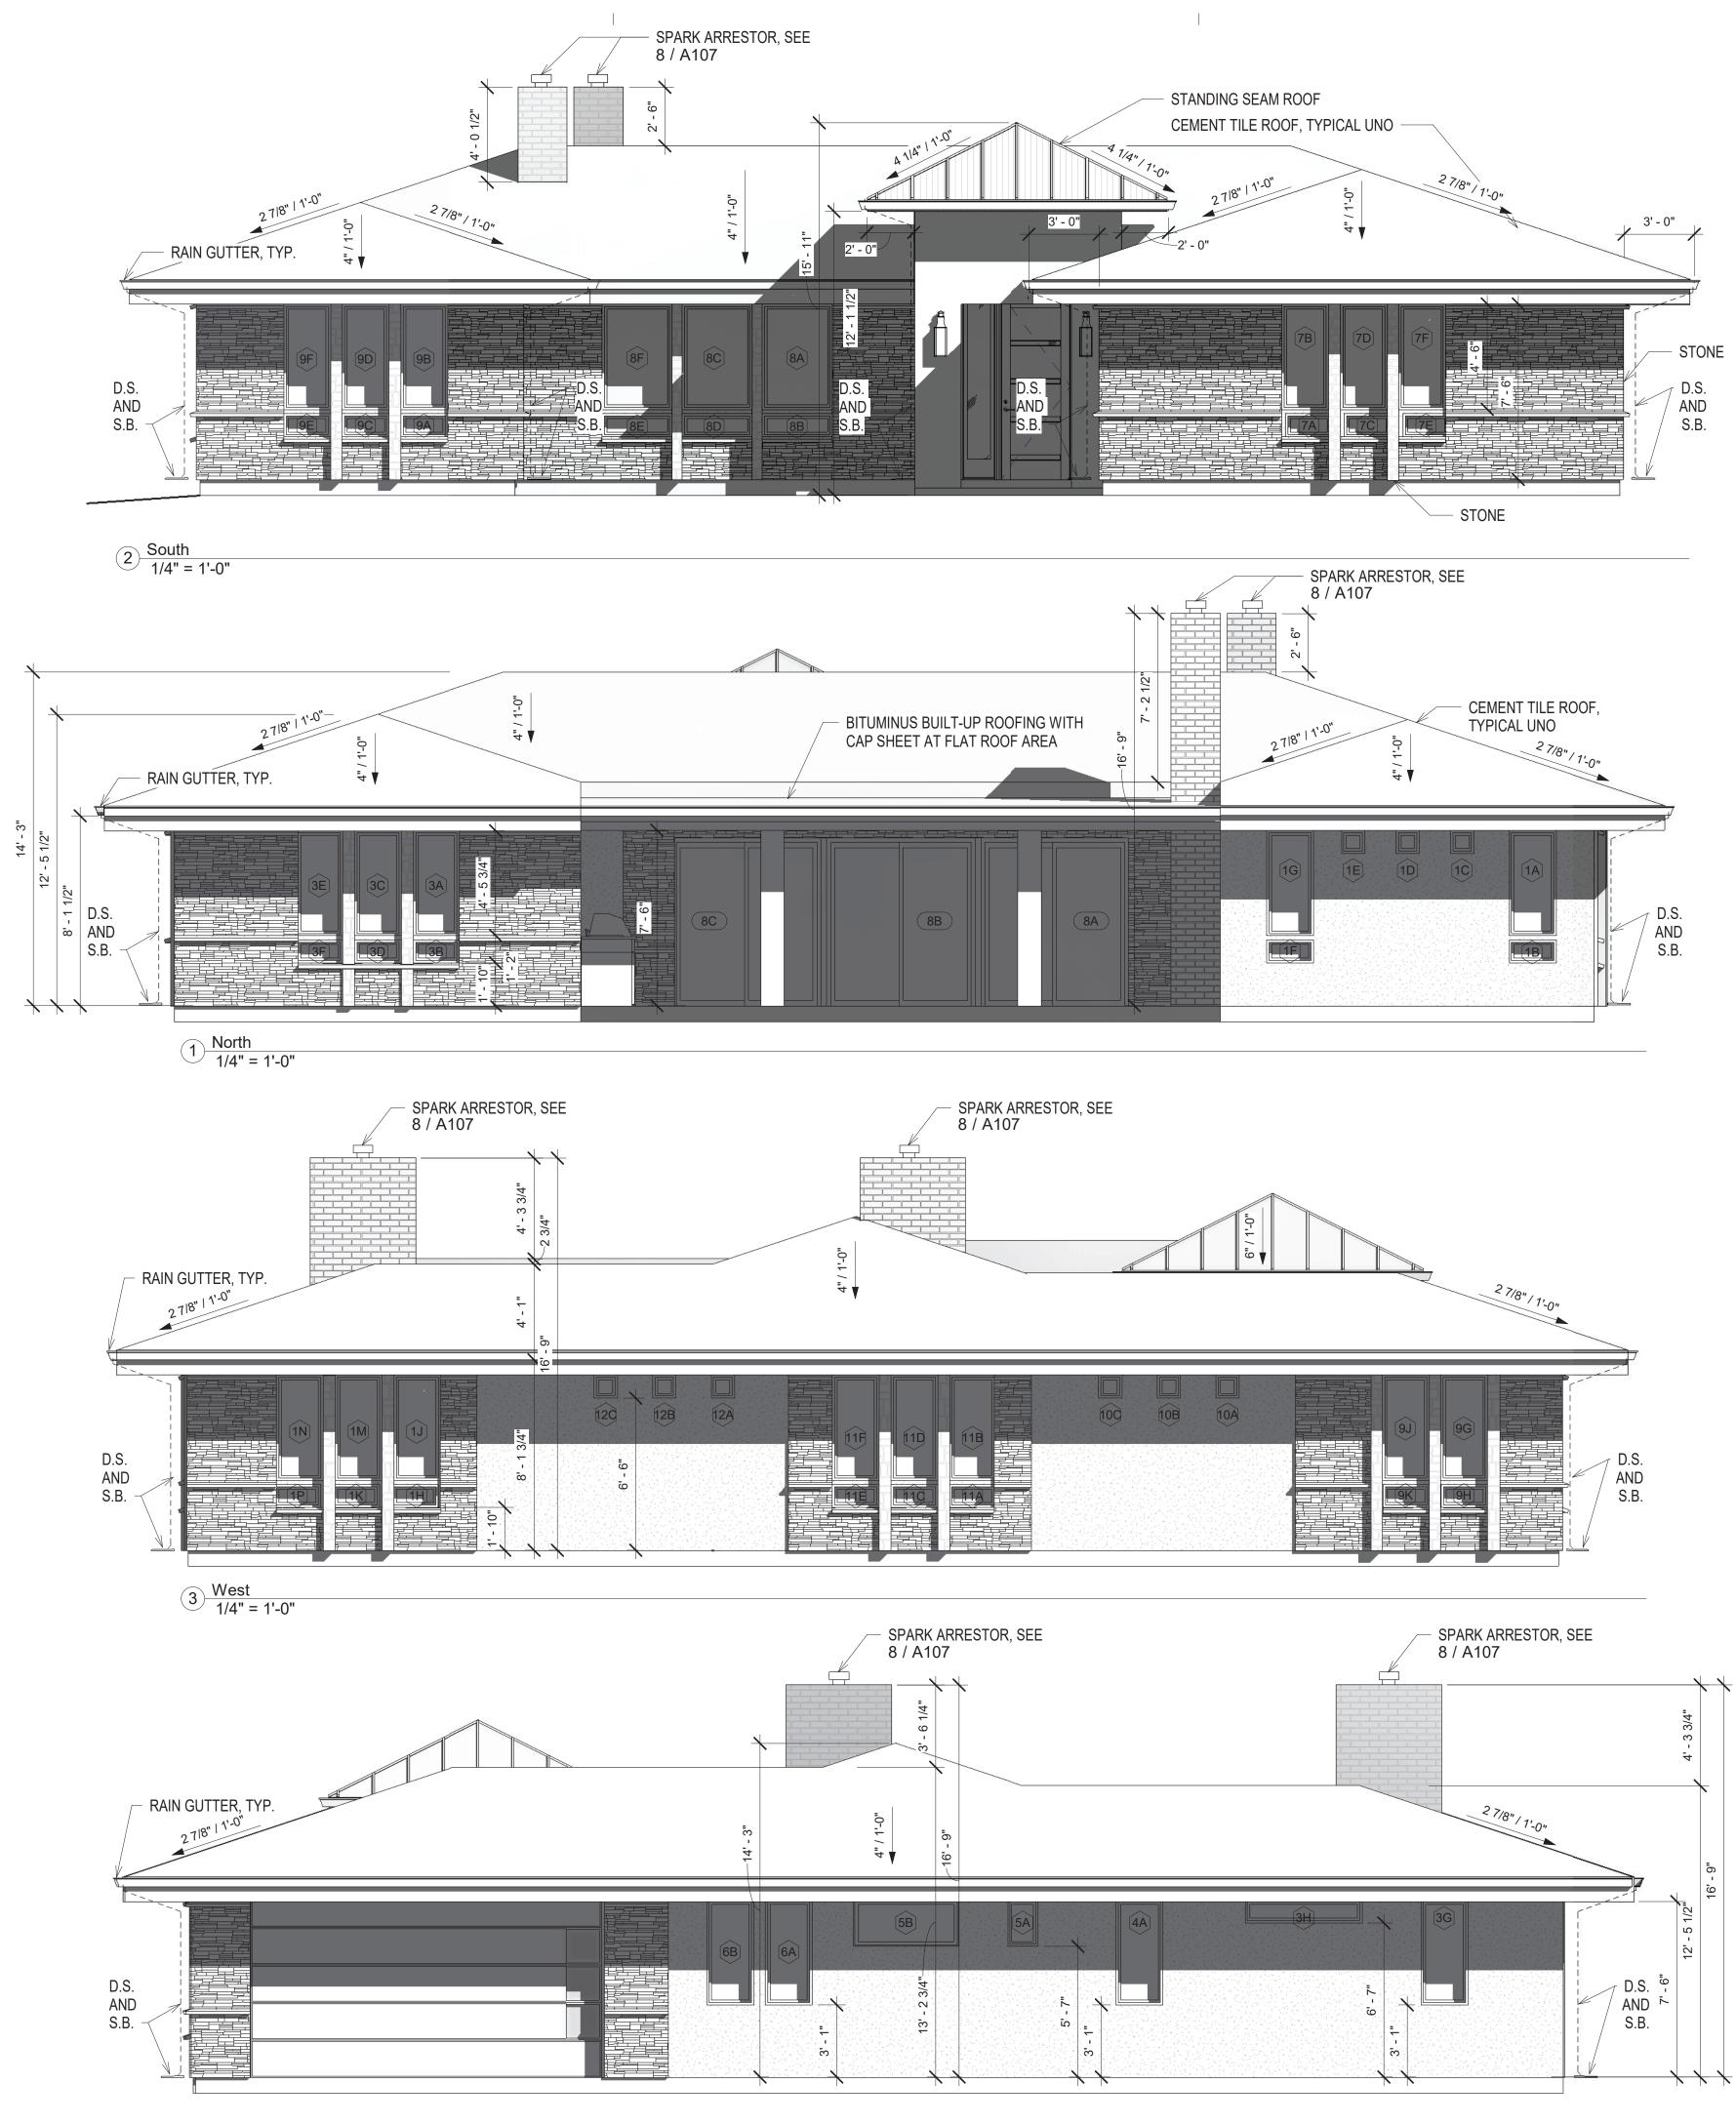

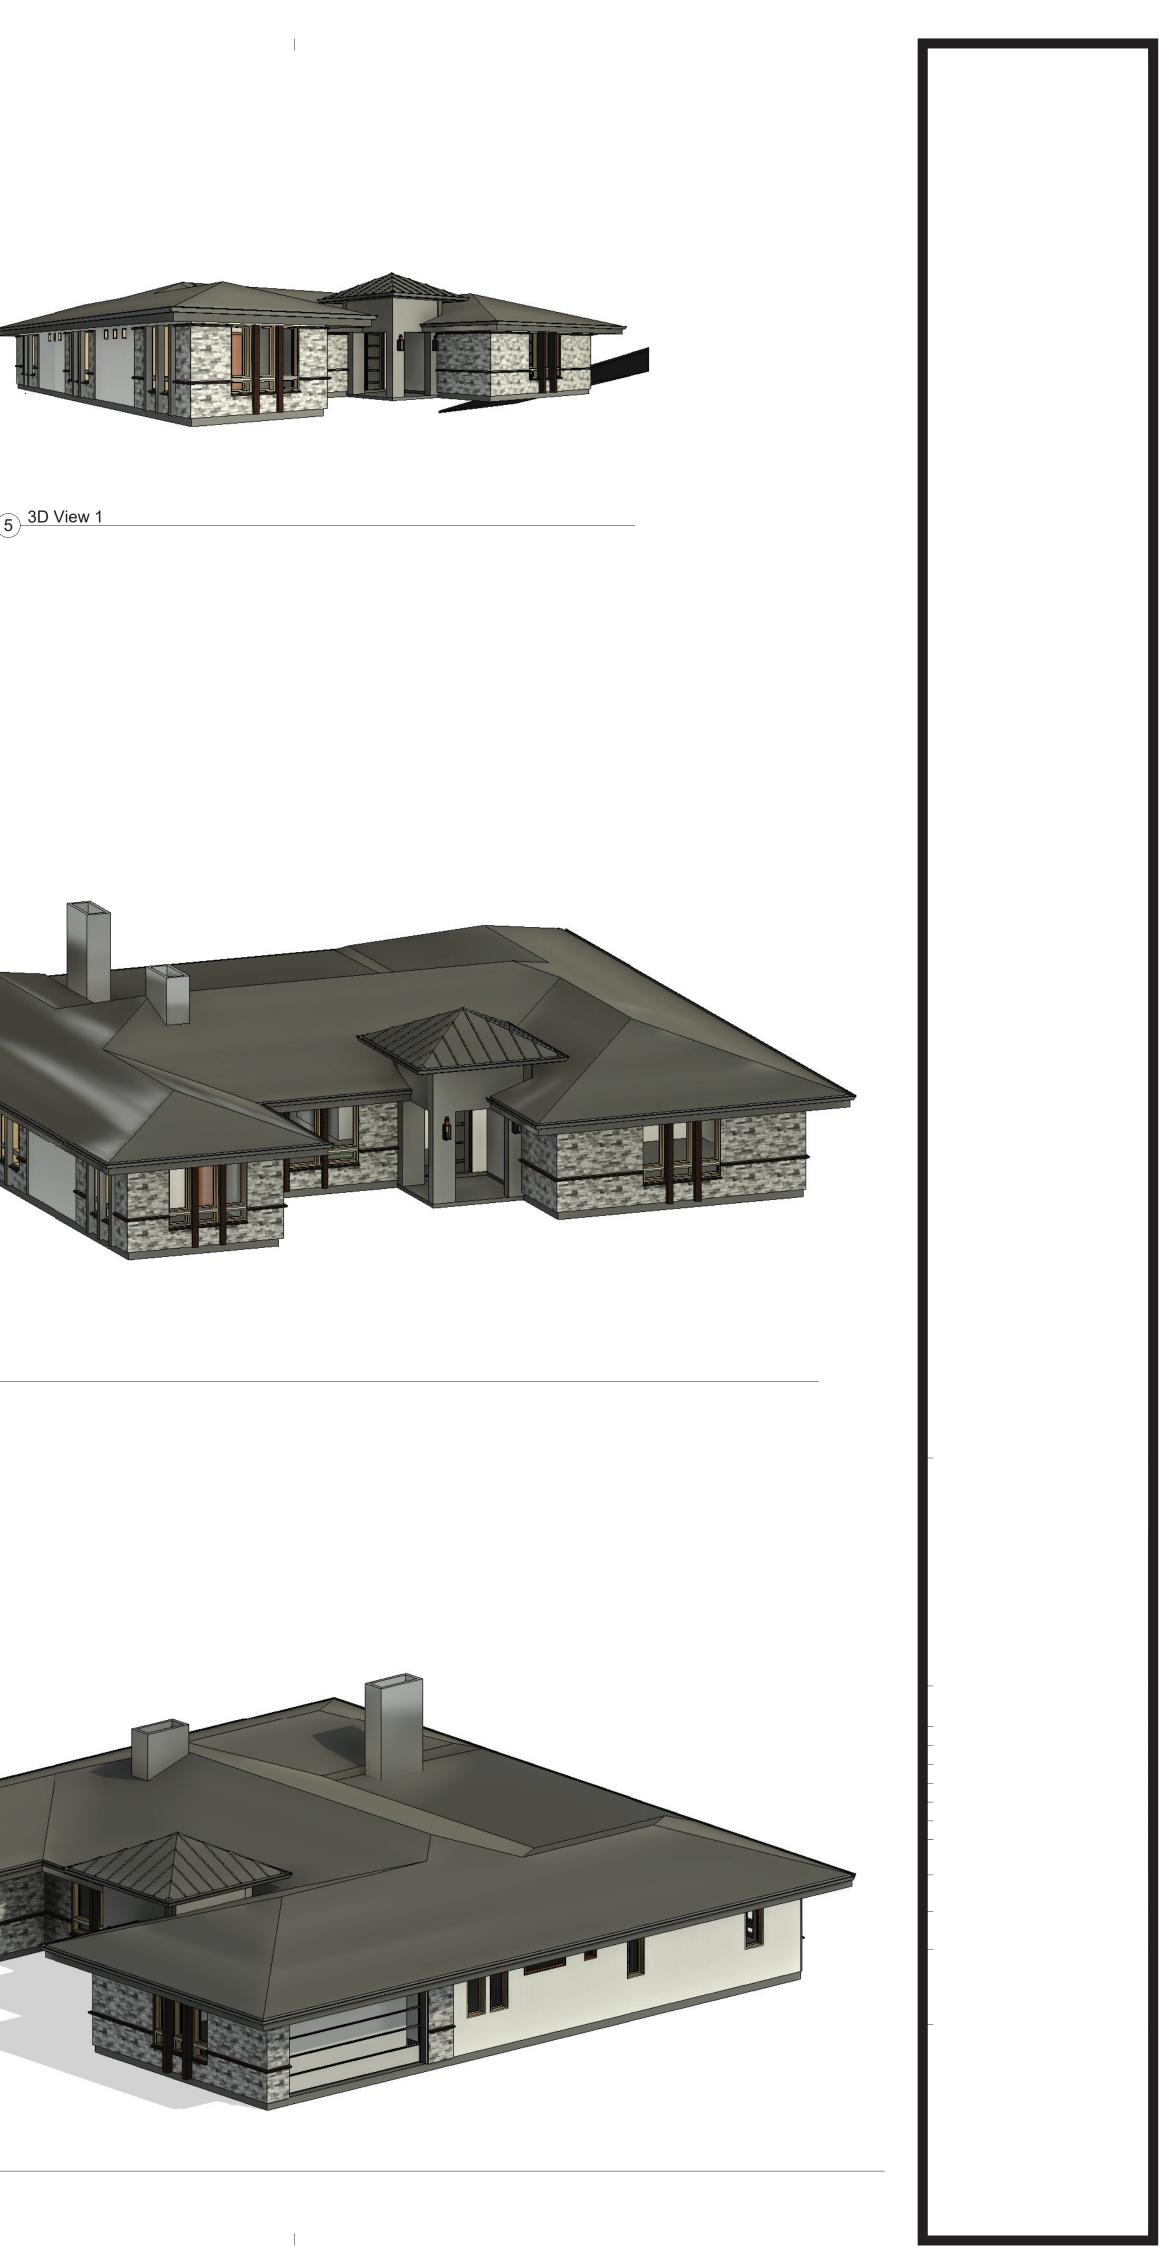


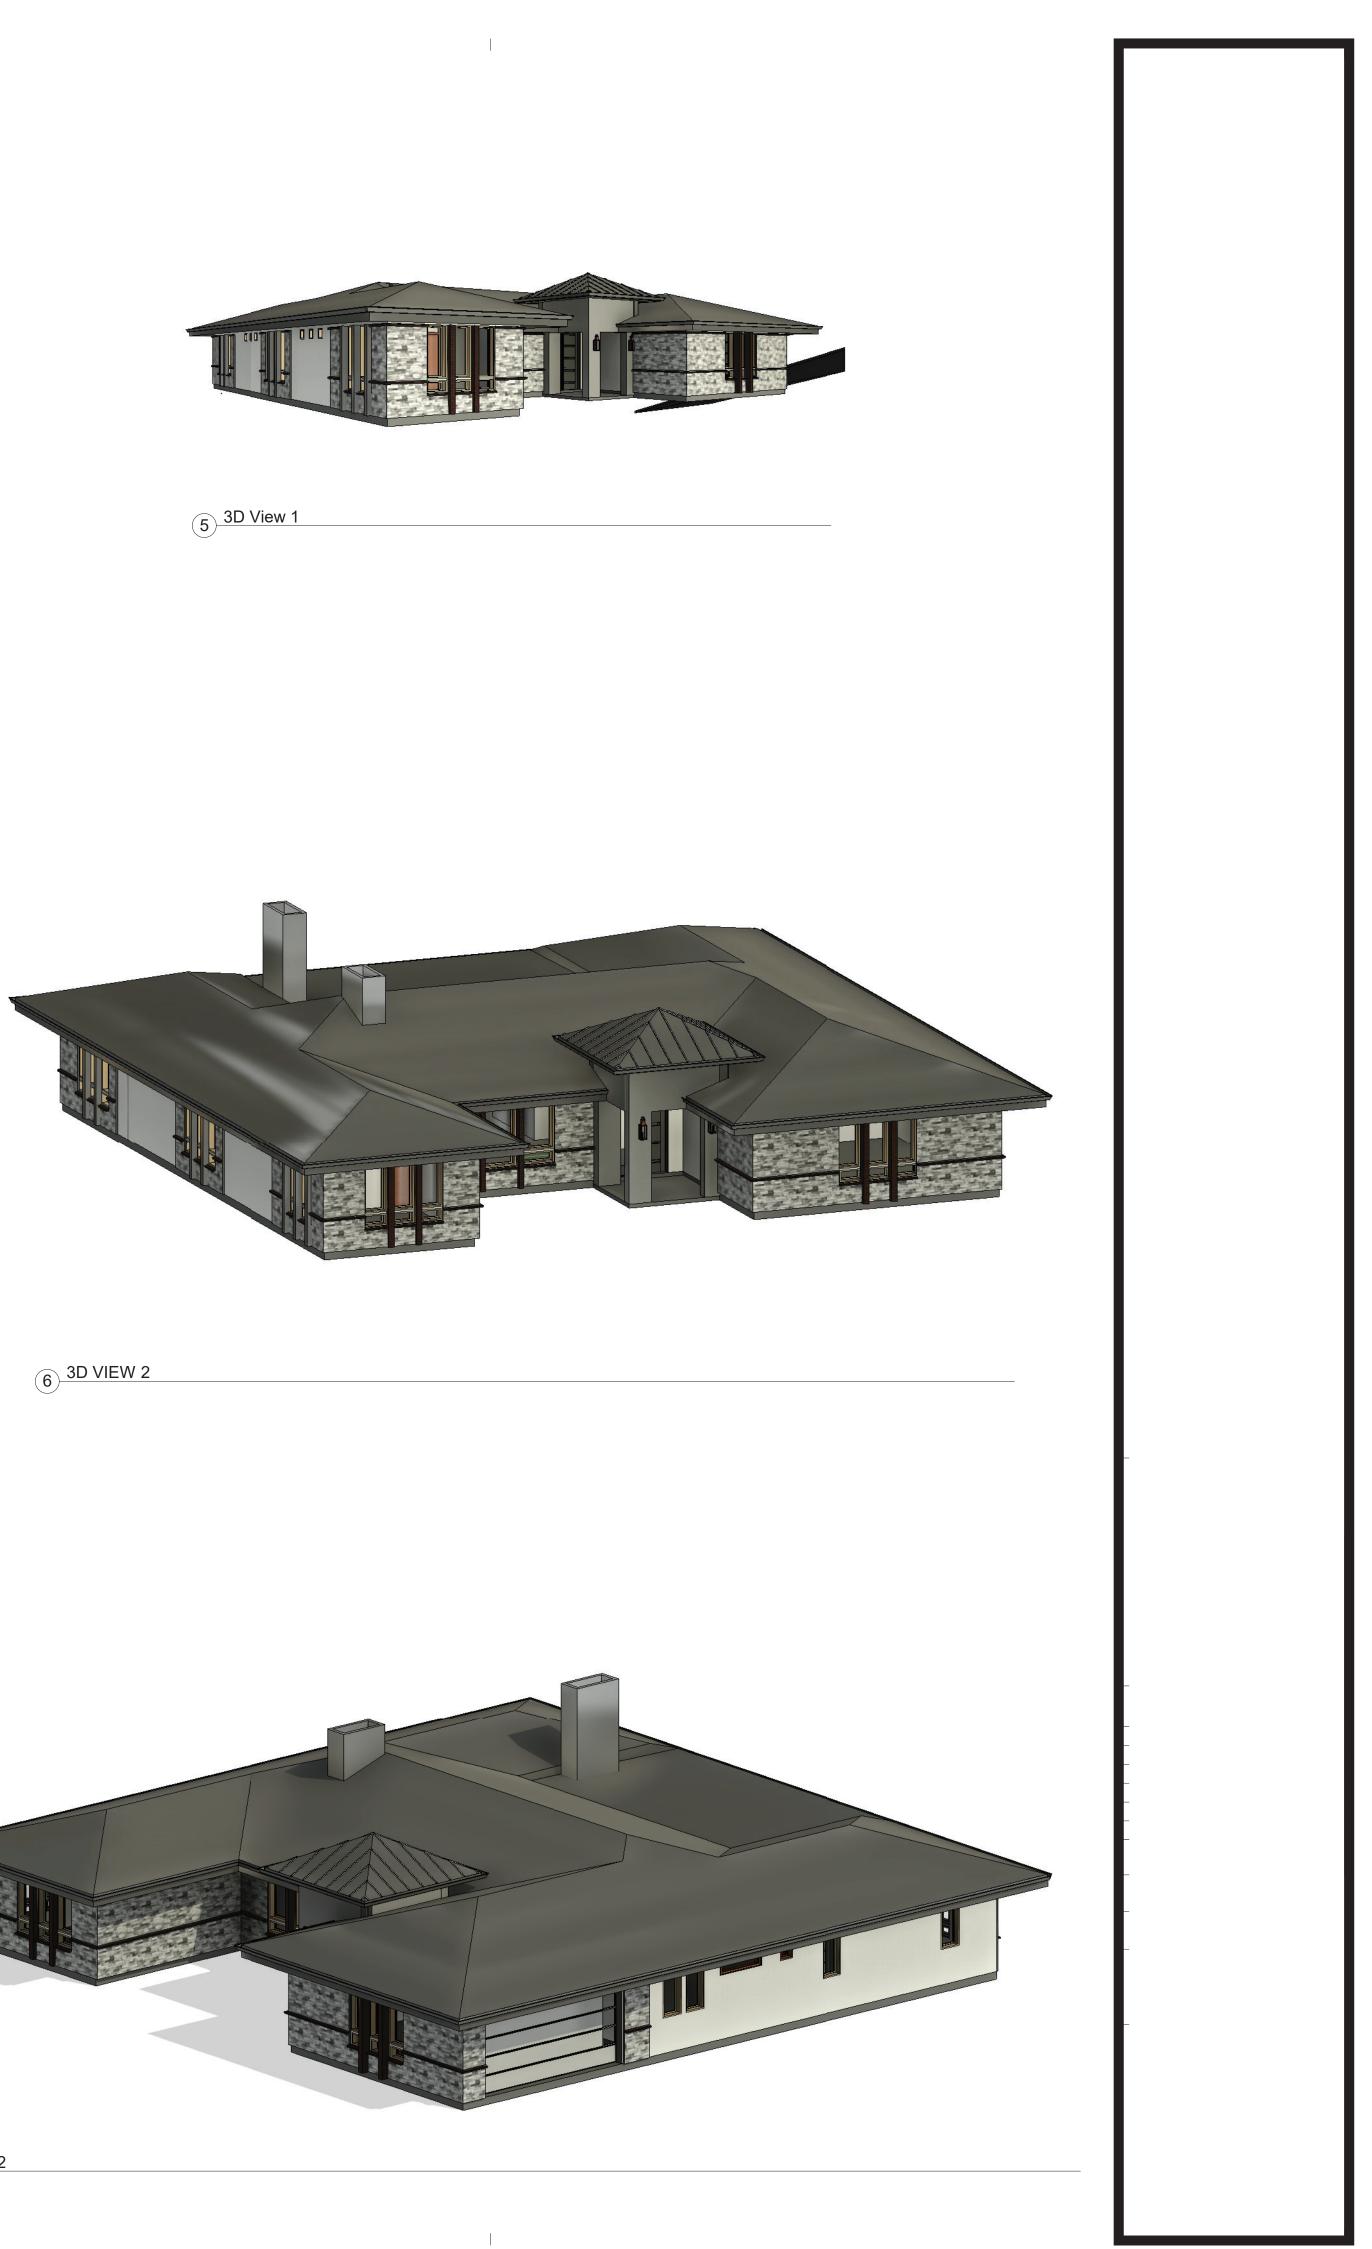




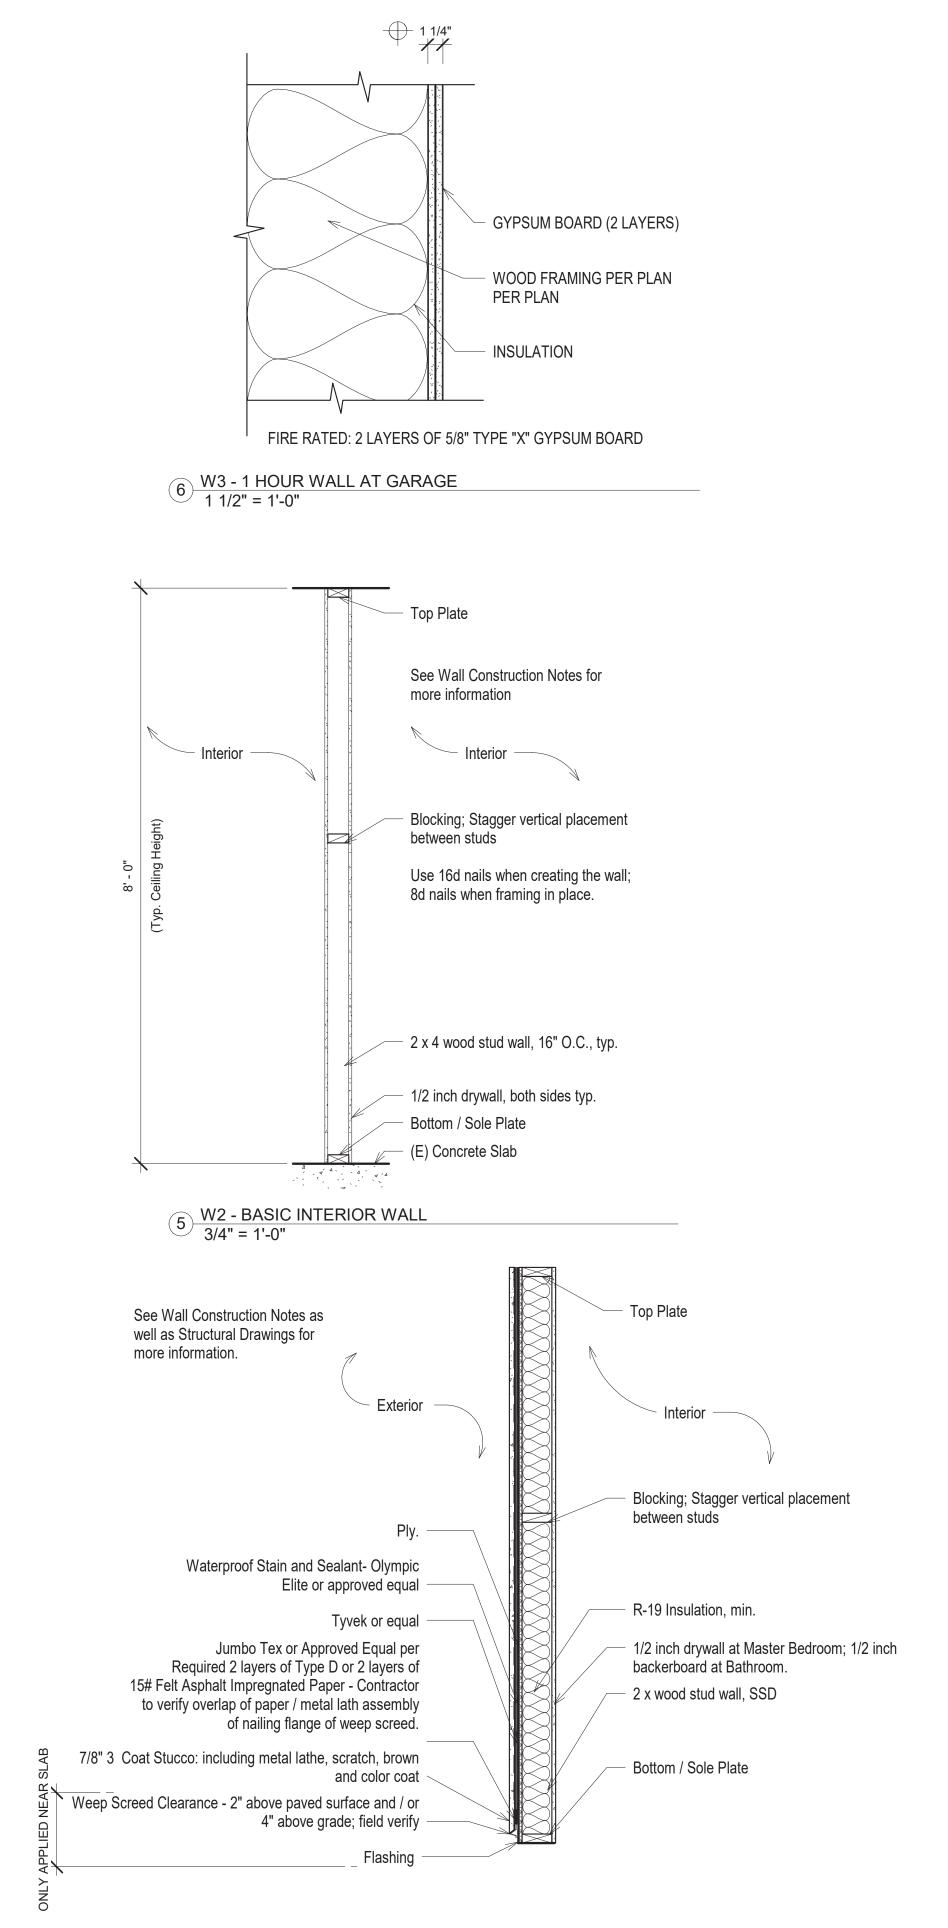



4 <u>W1 - STUCCO EXTERIOR</u> 3/4" = 1'-0"

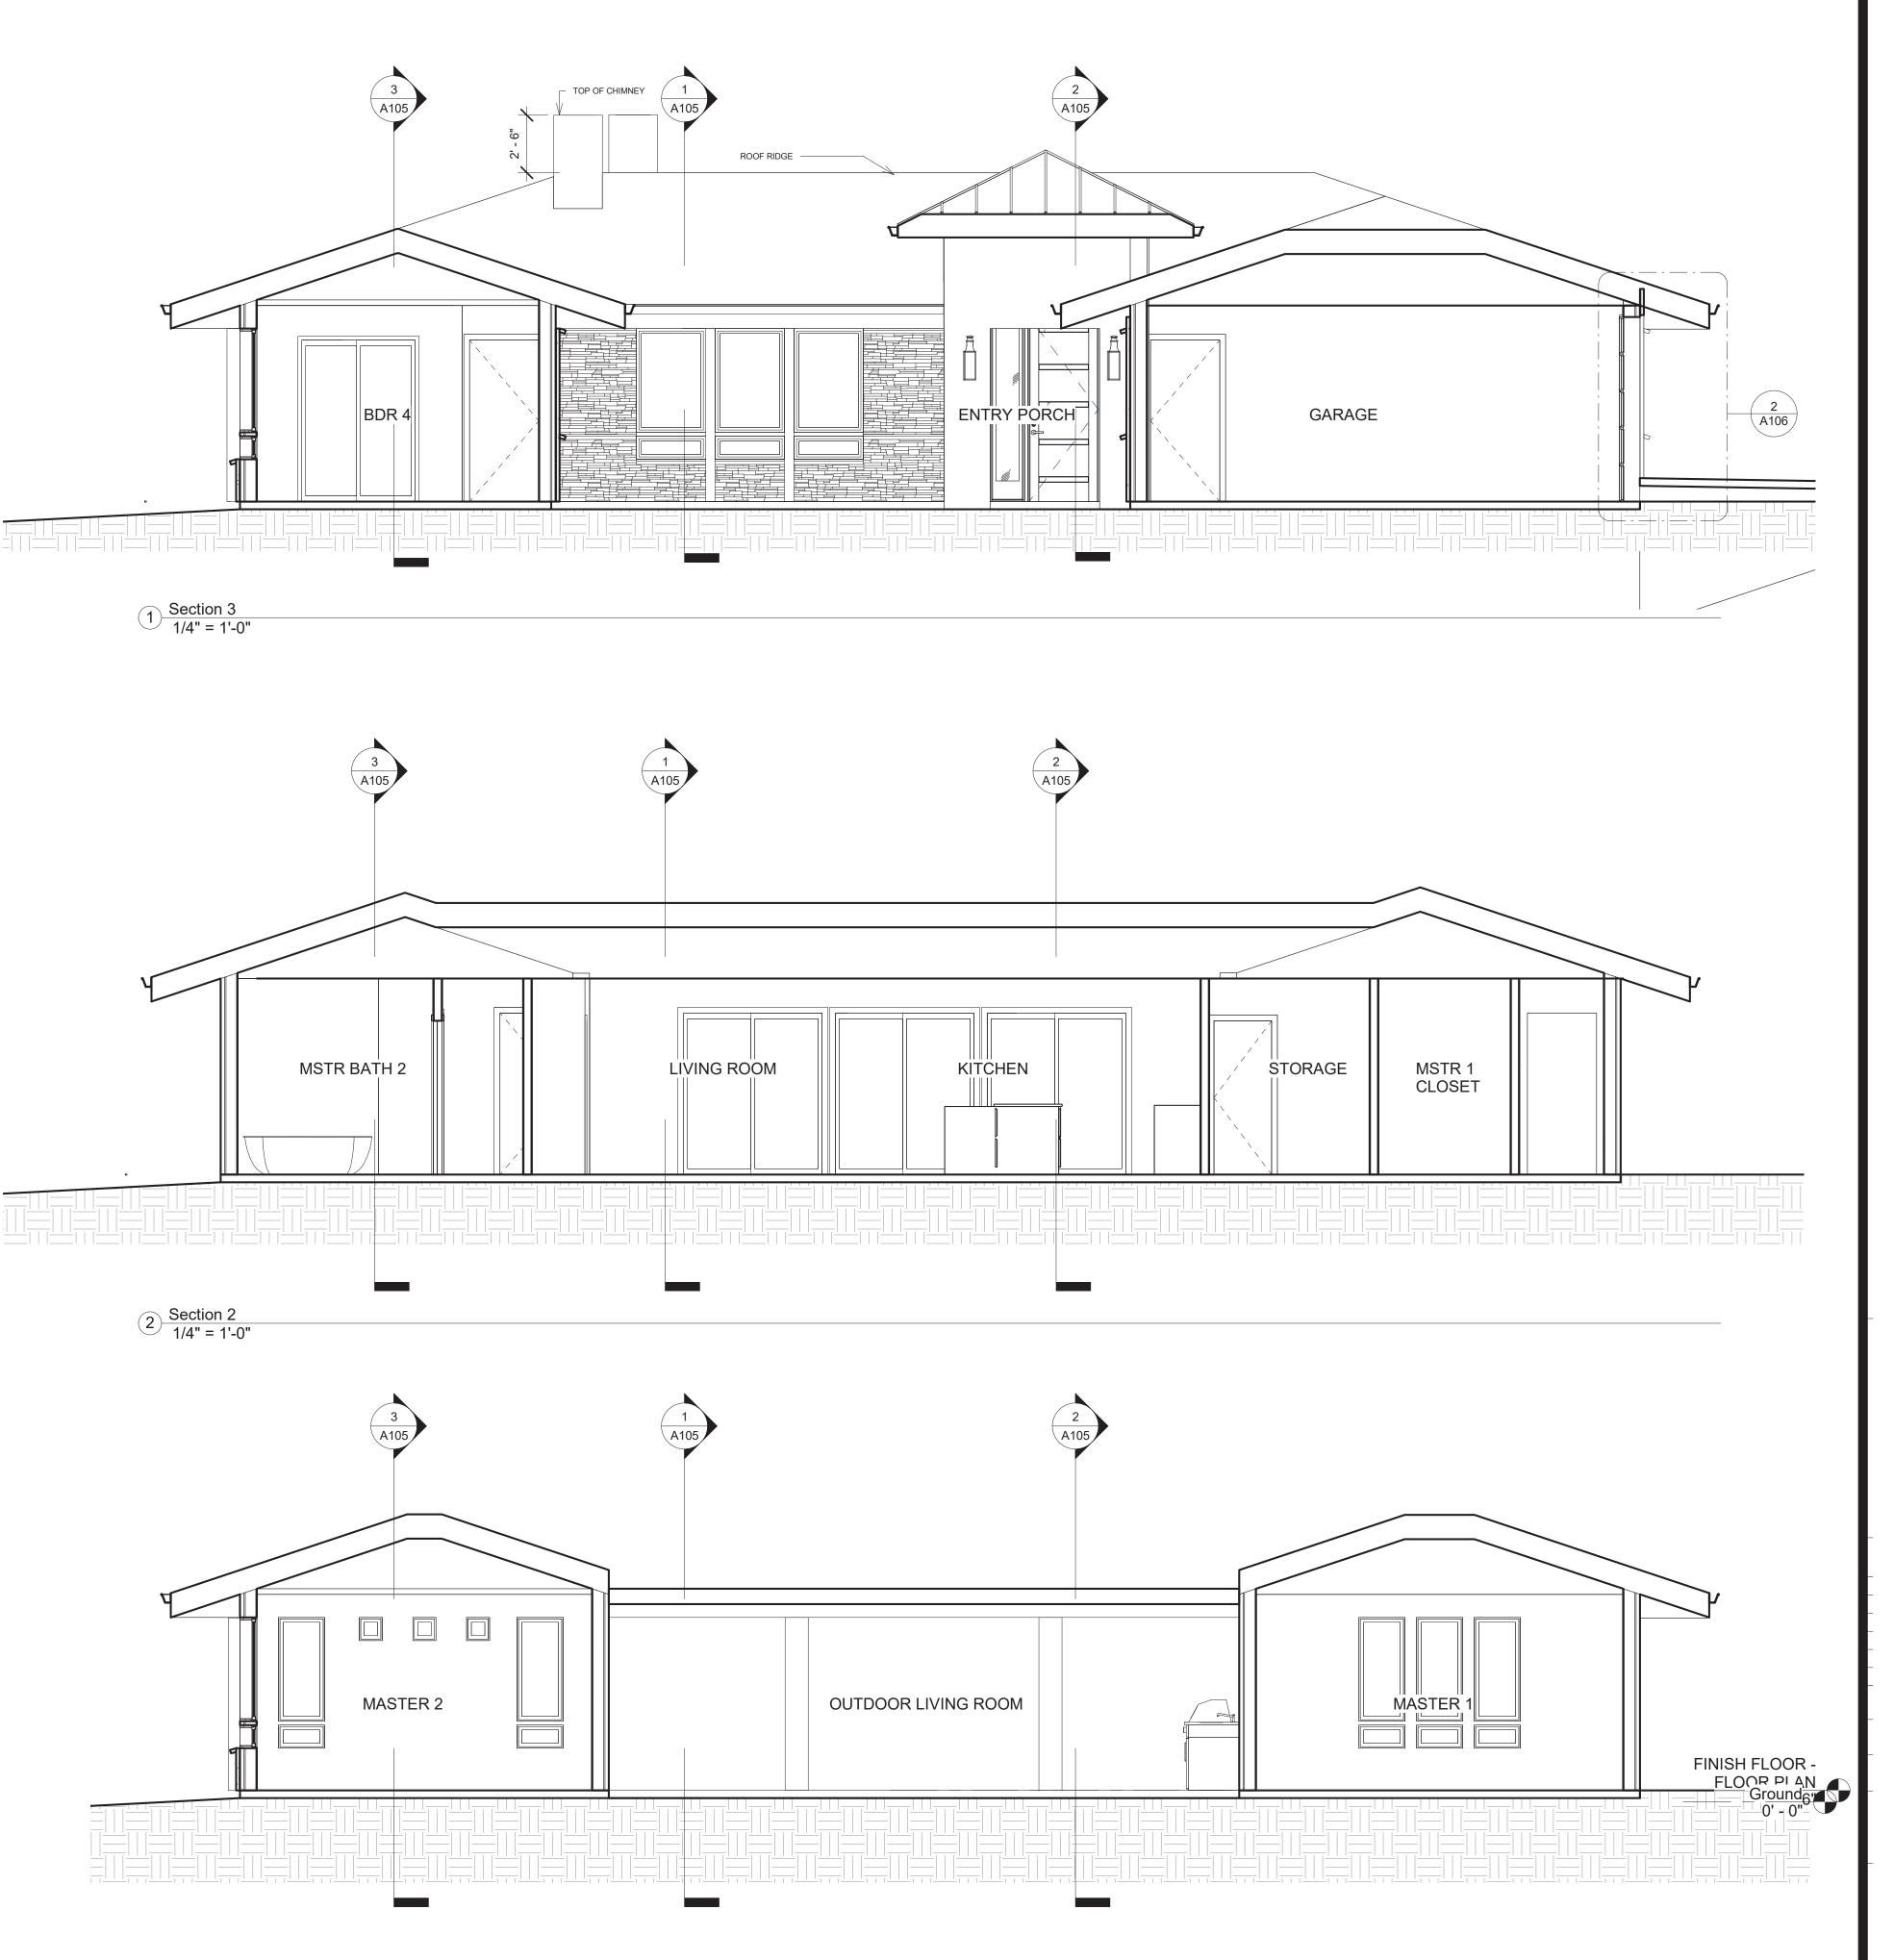

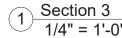


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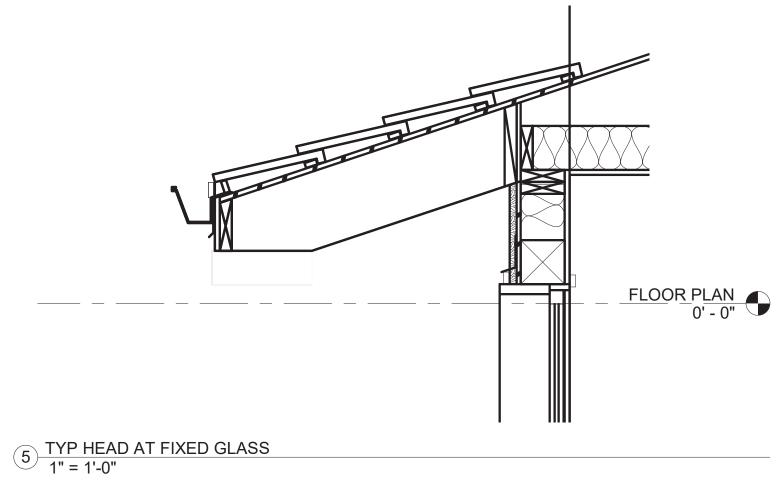


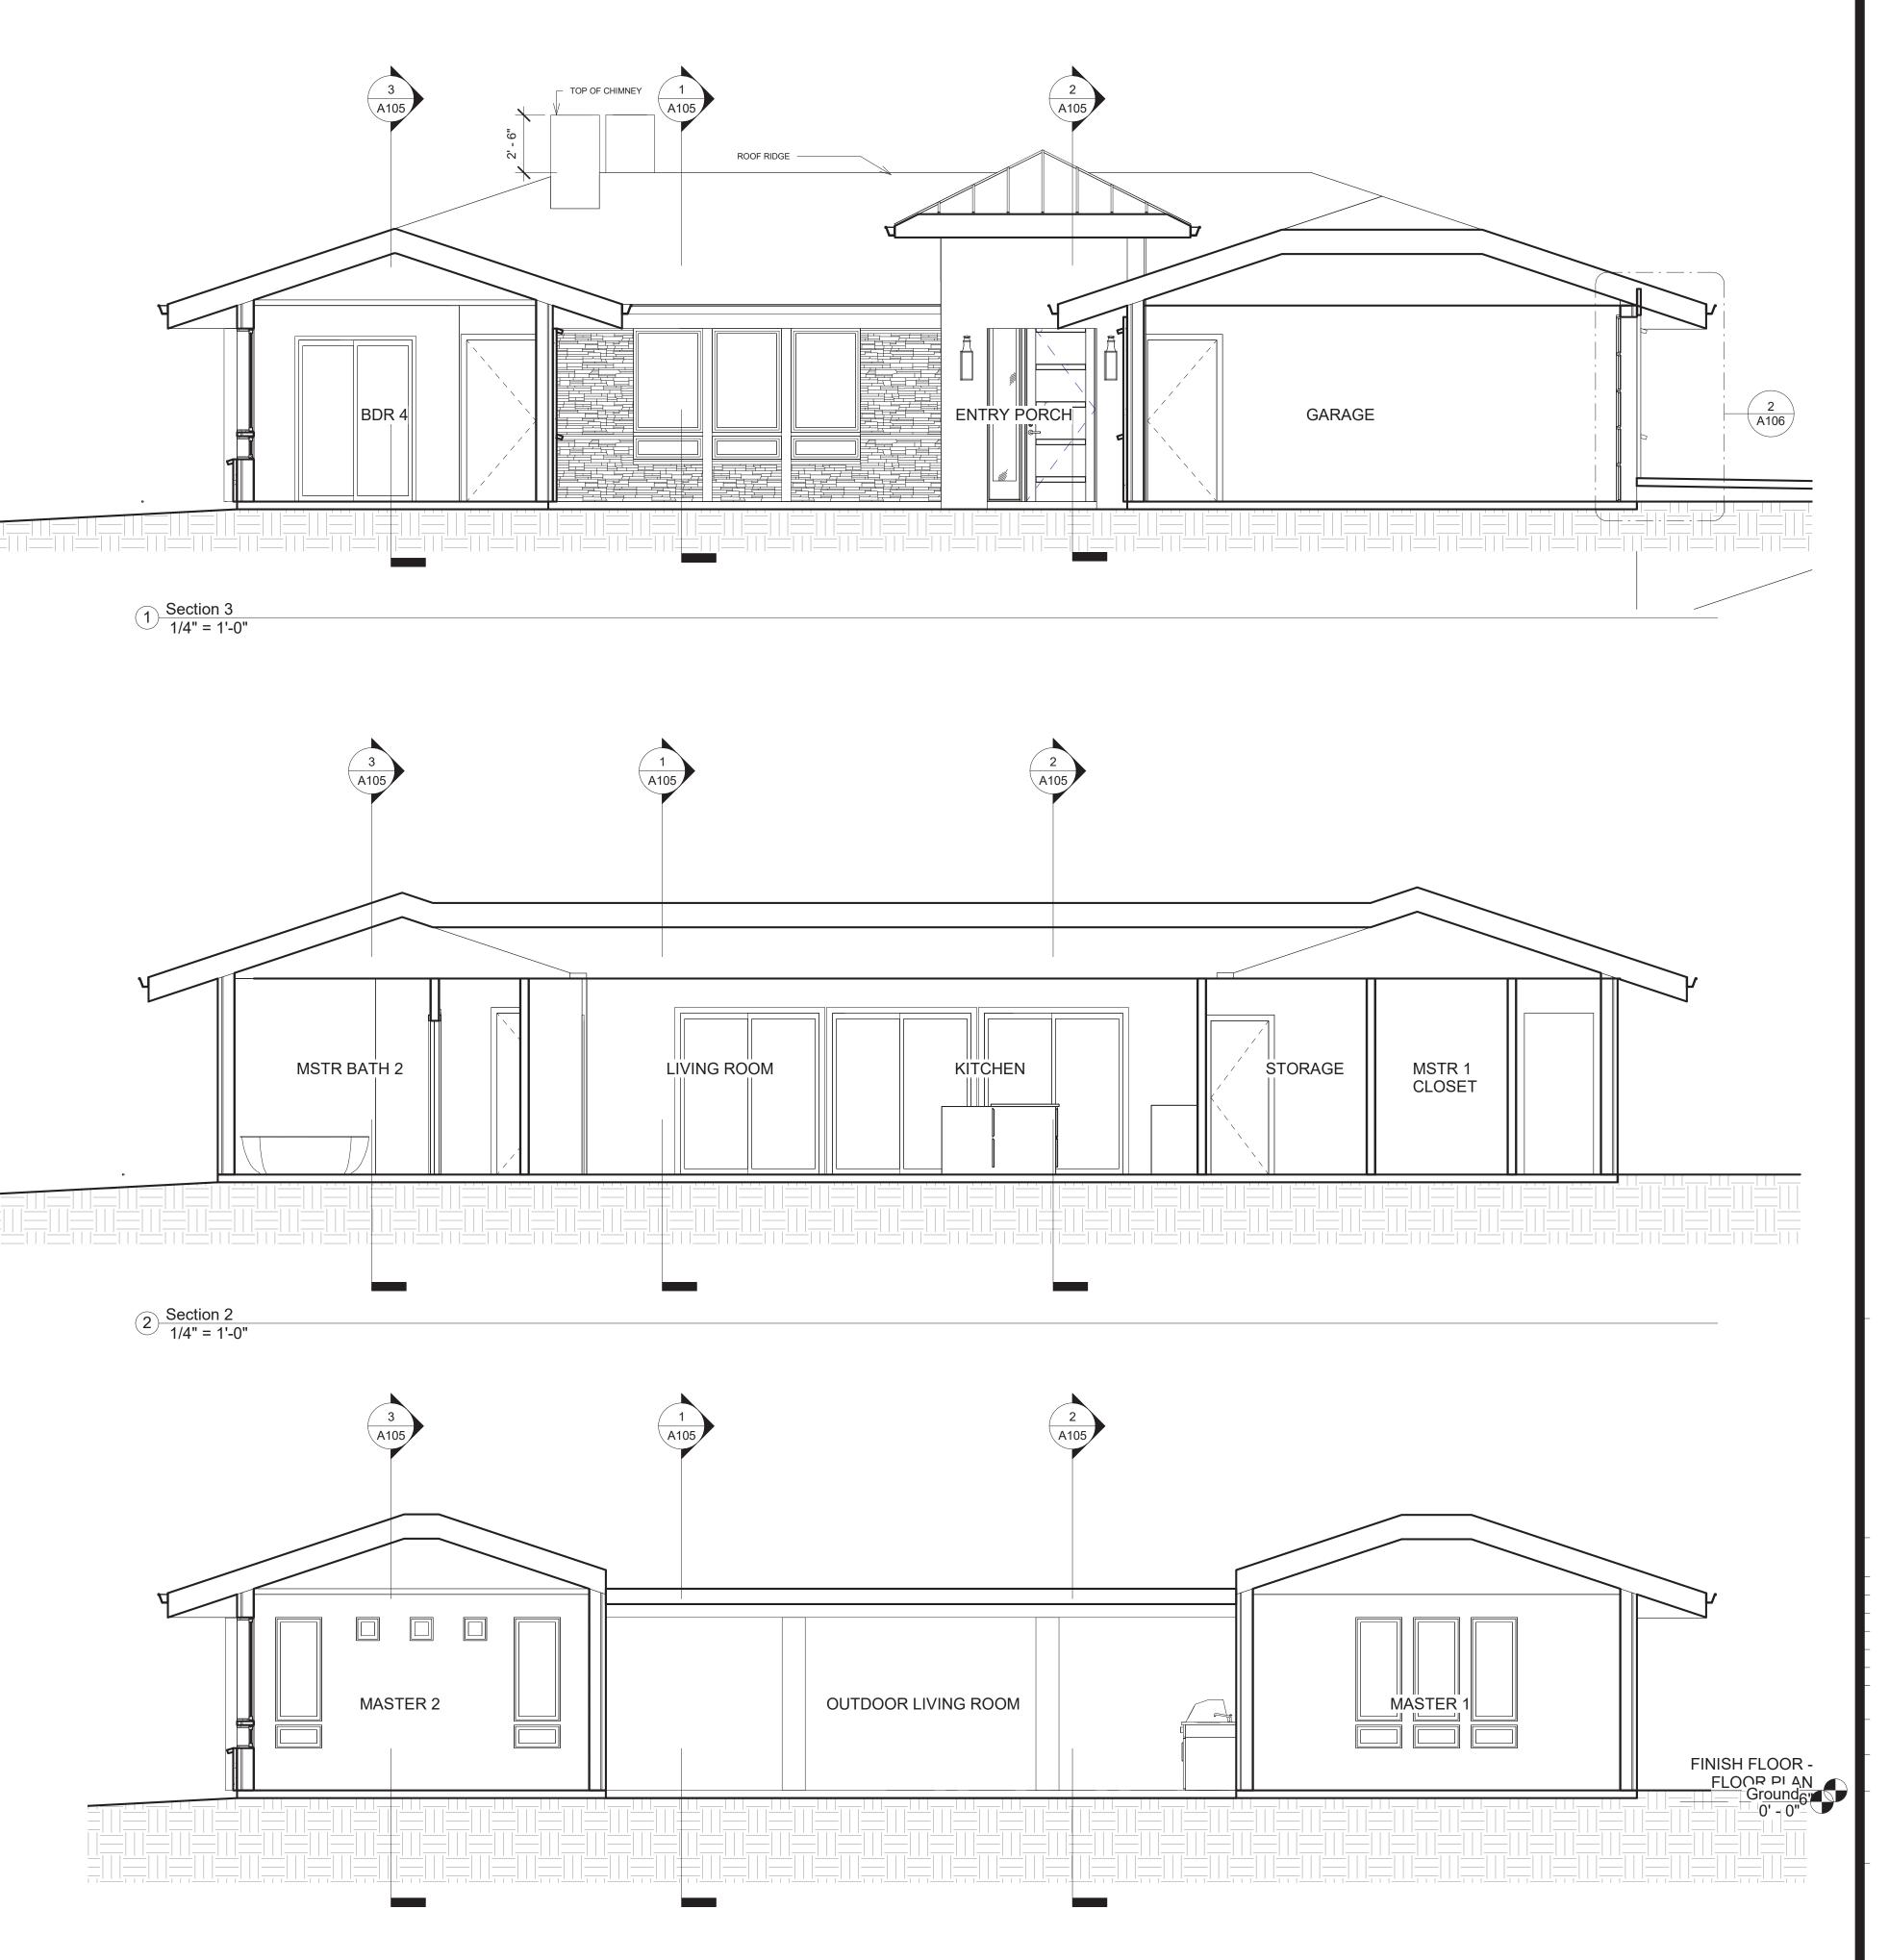


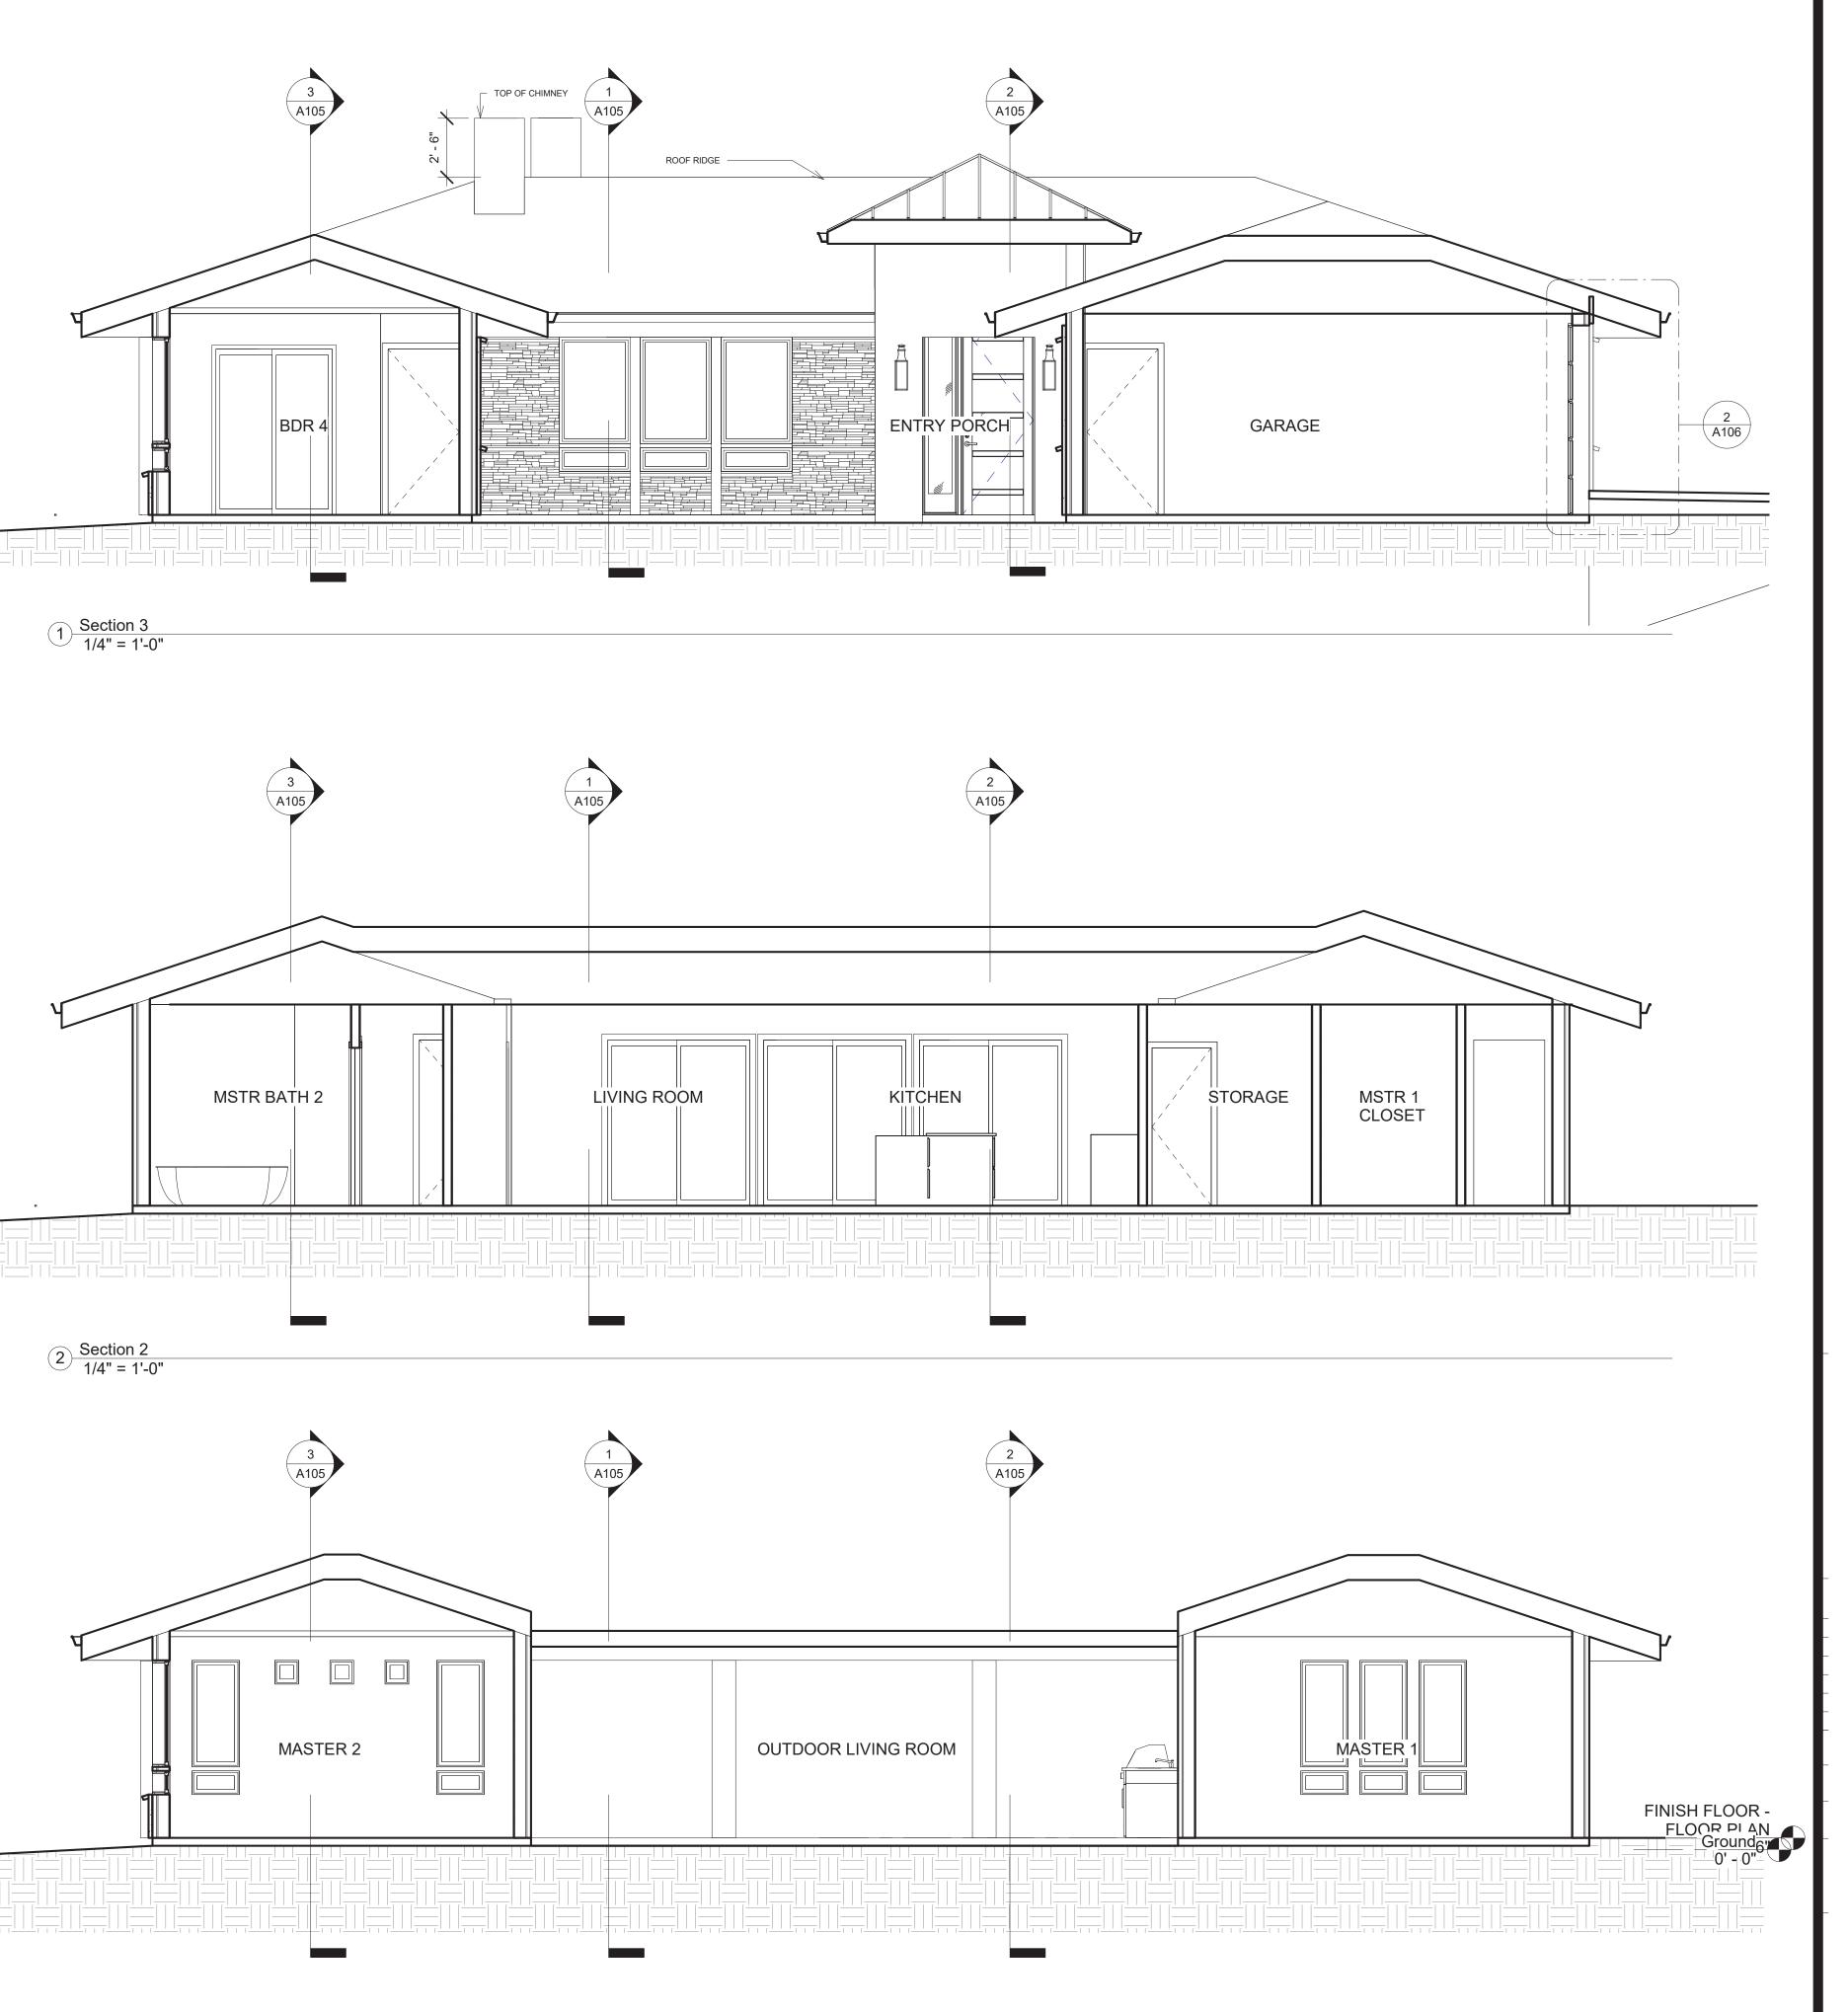

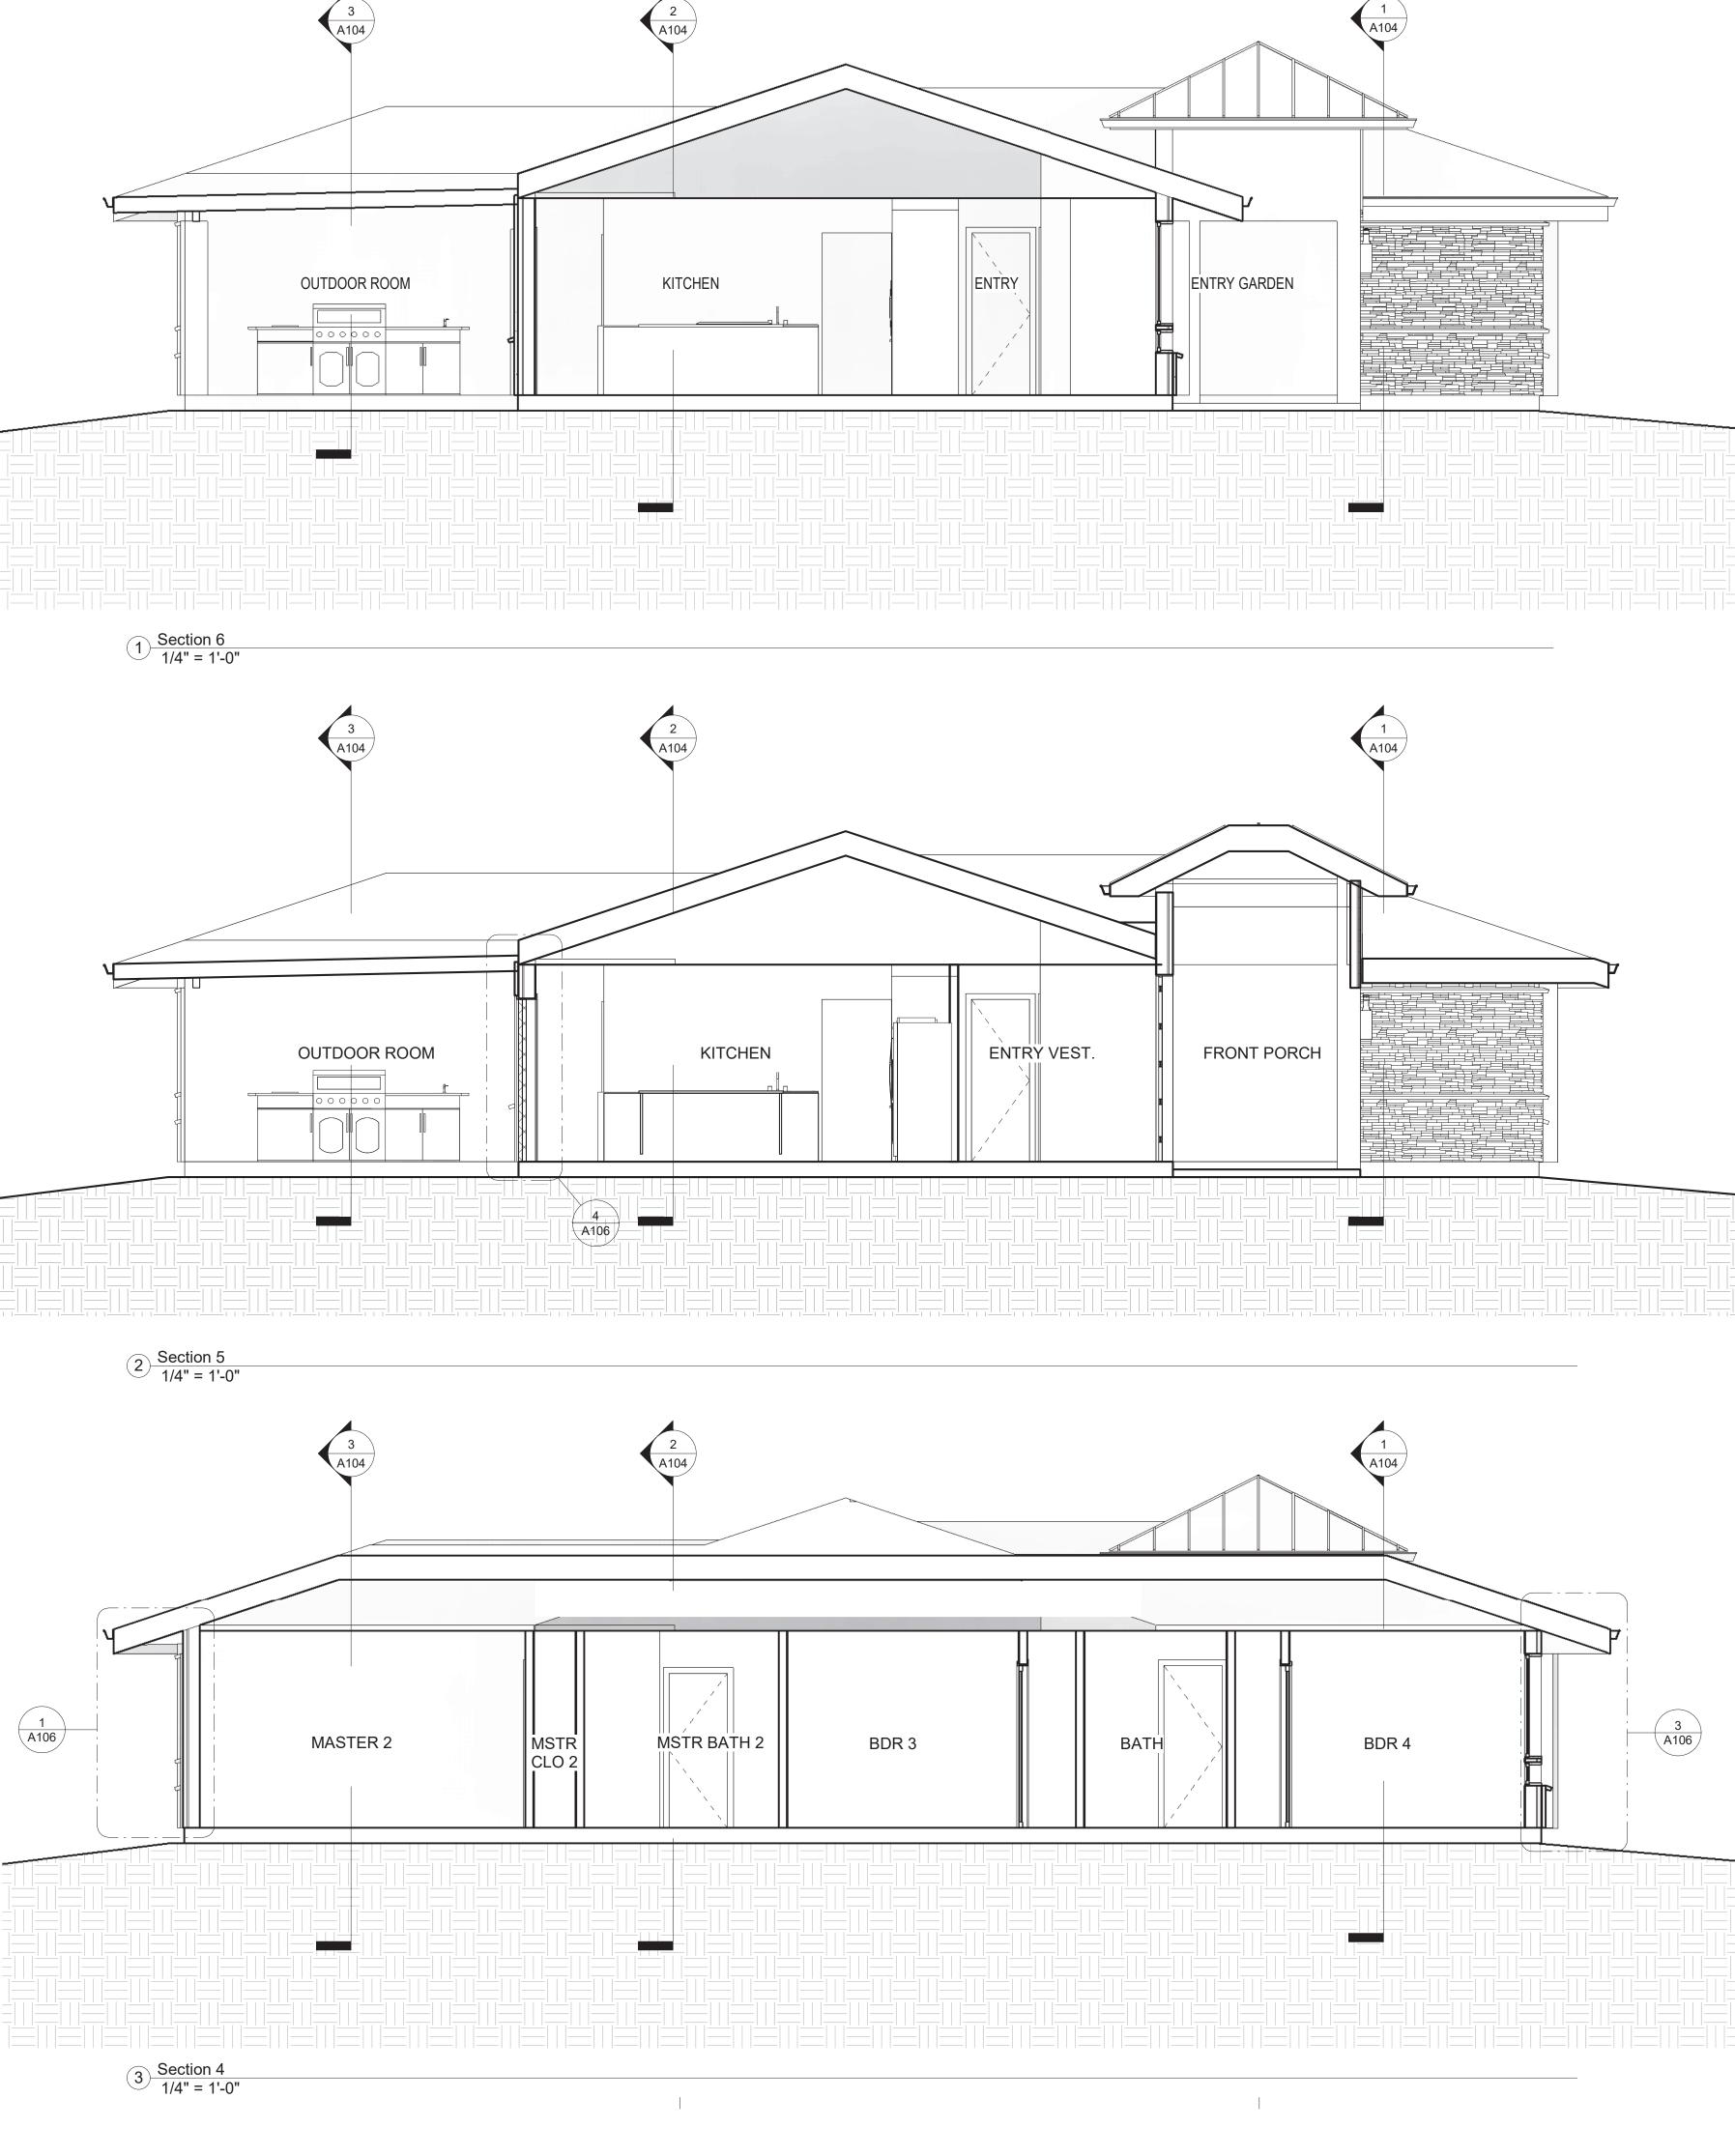


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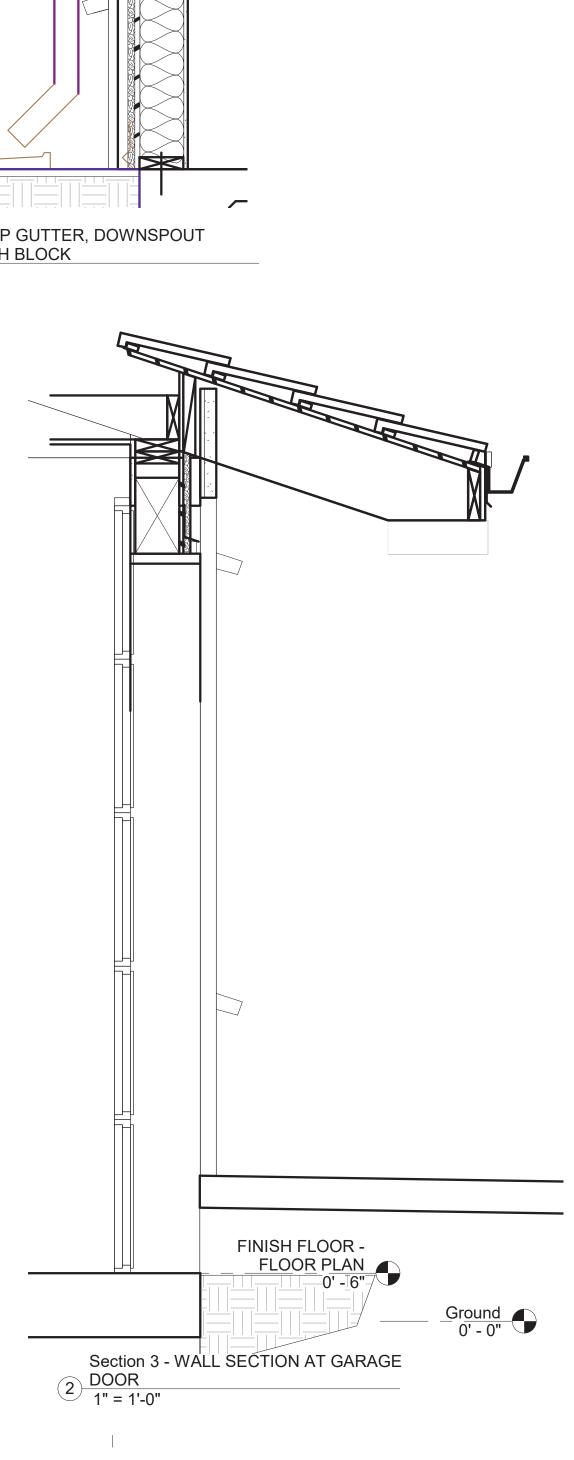


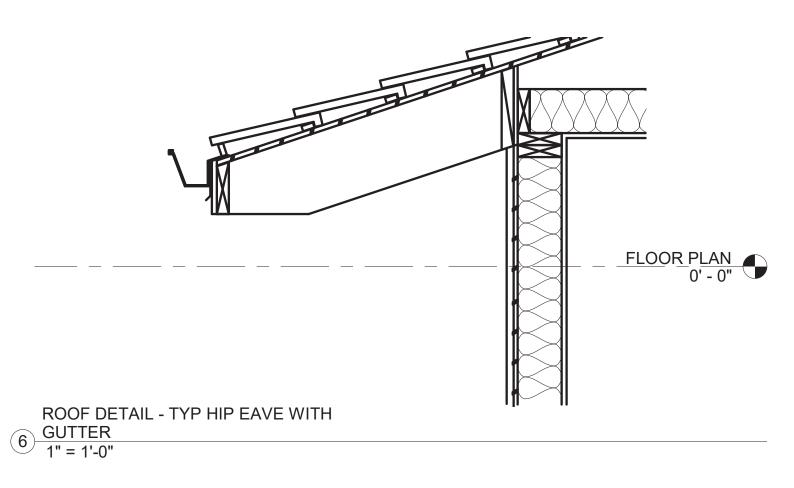



DETAIL NOTES

- 1. ALL HORIZONTAL AND VERTICAL DIMENSIONS TO BE VERIFIED IN THE FIELD PRIOR TO ANY WORK.
- 2. EXTERIOR WALL: 2 X 4 WOOD STUDS AT 16" O.C. FULL HEIGHT AS SHOWN ON EXTERIOR ELEVATIONS.
- EXTERIOR IS FINISHED WITH 7/8" EXTERIOR PLASTER (THREE COATS) OVER SELF-FURRING DIAMOND MESH OVER 2-LAYERS OF GRADE 'D' PAPER WITH R-21 BATT INSULATION.
- INTERIOR WALLS 2 X 4 WOOD STUDS AT 16" O.C. TO THE UNDERSIDE OF THE ROOF FRAMING WITH 5/8" TYPE 'X' GYPSUM BOARD EACH SIDE FULL HEIGHT WITH BATT INSULATION.
- 5. SLOPE FINISHED DECK AWAY FROM BUILDING 2% MAXIMUM AND 1% MINIMUM.
- 6. ALL OCCUPIABLE SPACES TO BE INSULATED WITH MINIMUM R-21 IN EXTERIOR WALLS AND R-30 IN CEILING / ROOF SPACES.
- 7. REFER TO STRUCTURAL DRAWING FOR SIZES AND CONNECTIONS OF ALL STRUCTURAL ELEMENTS.
- THE PURPOSE OF ALL BUILDING SECTIONS IS TO CLARIFY DESIGN INTENT. REFER TO FLOOR PLANS, REFLECTED CEILING PLANS, AND ELEVATIONS PRIOR TO COMMENCING OR PROCEDING WITH THE WORK.



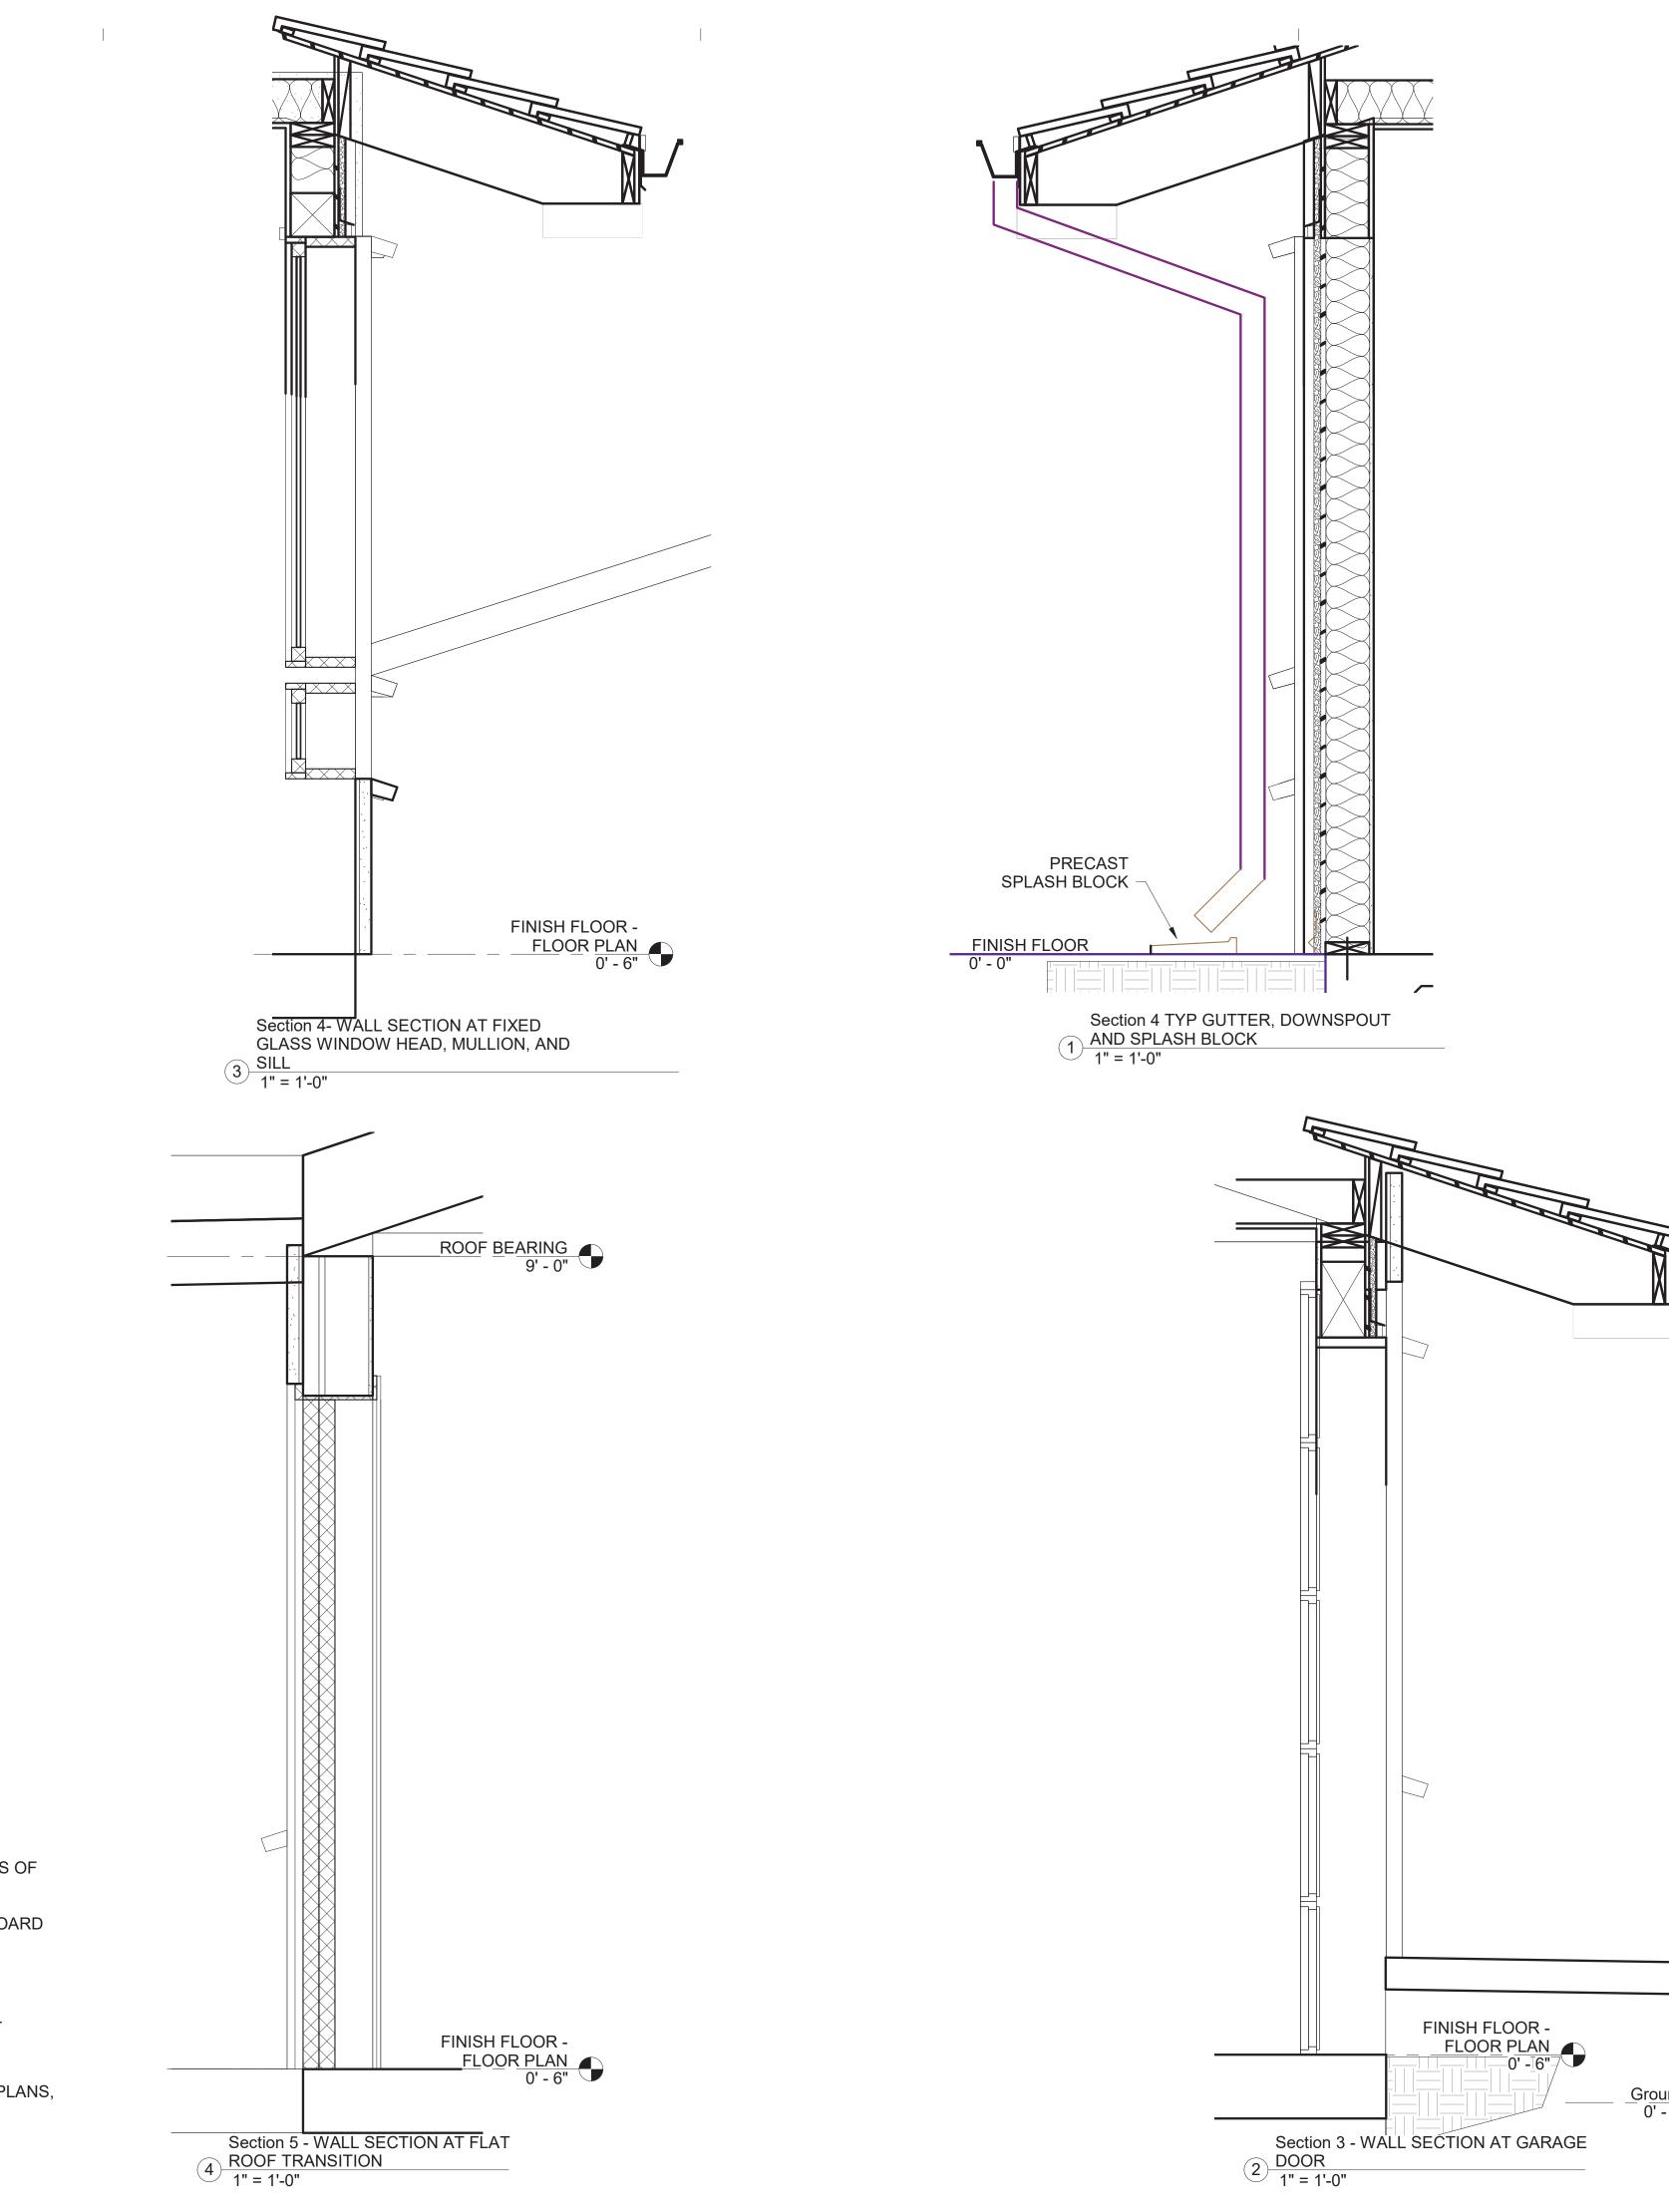

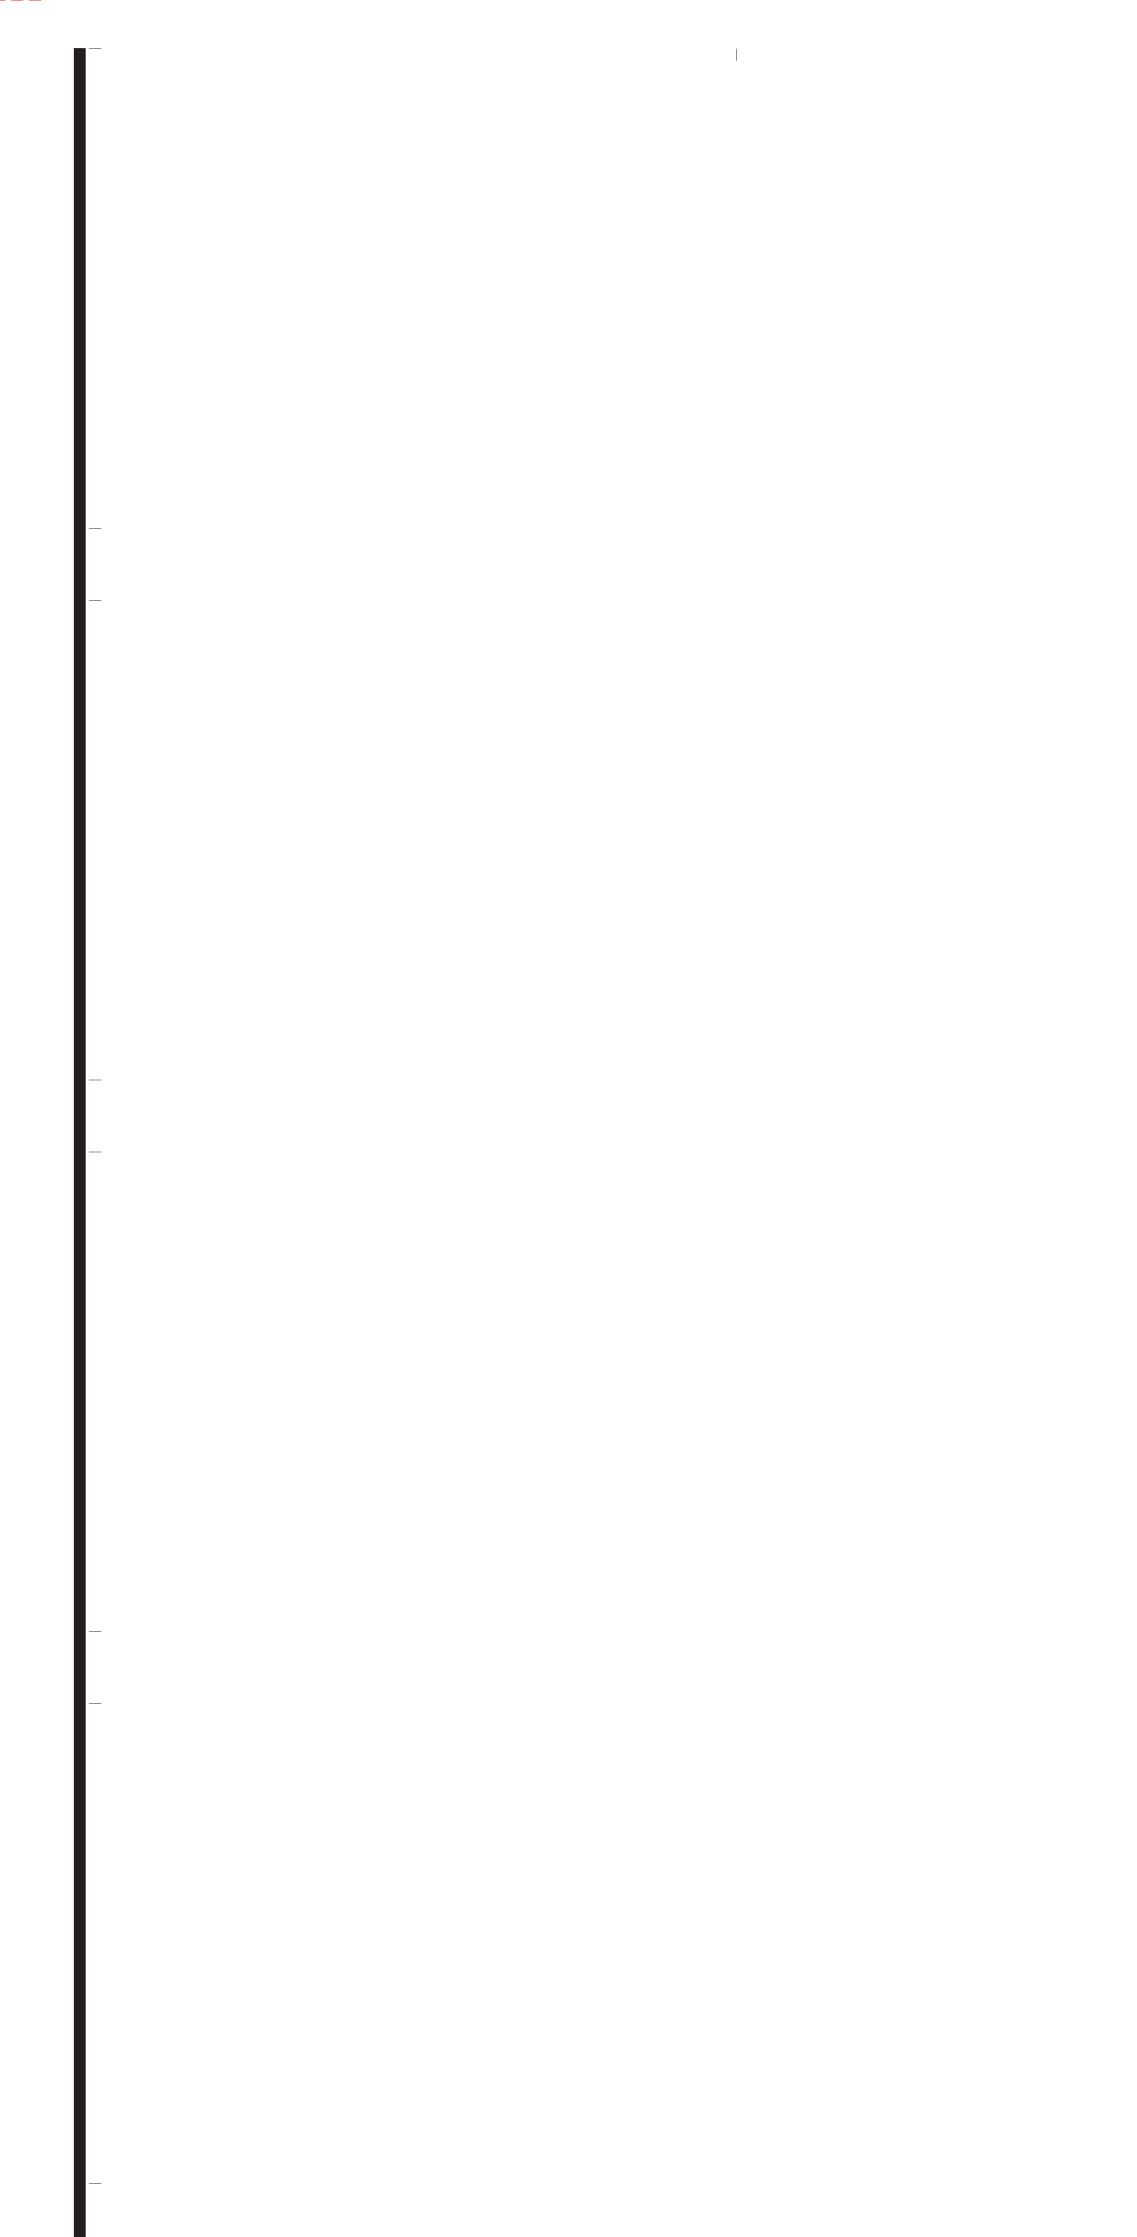

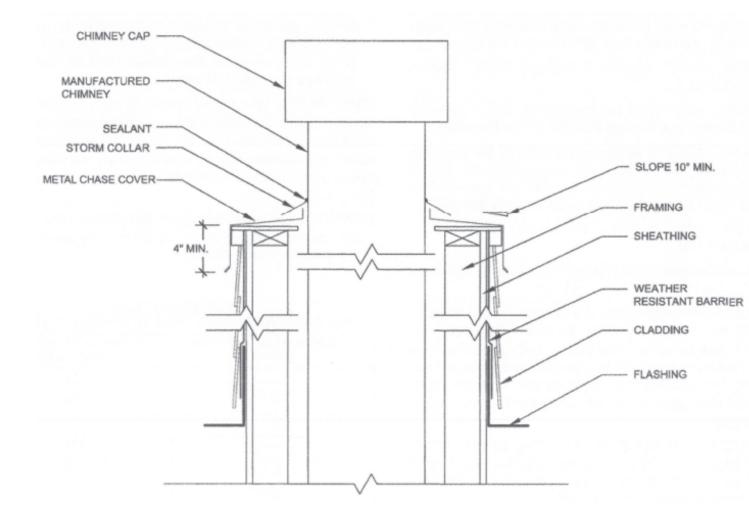

8 SPARK ARRESTOR 3/4" = 1'-0"

